LINDEN AVENUE PHASE 2 AND SPRUCE AVENUE TRAFFIC CALMING IMPROVEMENTS PROJECT - ATP

LINDEN AVENUE BETWEEN MILLER AVENUE AND CALIFORNIA AVENUE SPRUCE AVENUE BETWEEN TAMARACK LANE AND MAPLE AVENUE IN SOUTH SAN FRANCISCO

PROJECT NO. ST1602, BID NO. 2640


FEDERAL AID PROJECT NO. ATPL-5177(037)

TO BE SUPPLEMENTED BY STATE OF CALIFORNIA DEPARTMENT OF TRANSPORTATION STANDARD PLANS DATED 2015



INDEX OF DRAWINGS:

	•••••••••••••••••••••••••••••••••••••	
6-7 8-11 12-15 16-25 26-27 28-31 32-35 36-42 43-46 47-50 51-53	K-1 TO K-2 DM-1 TO DM-4 L-1 TO L-4 CD-1 TO CD-10 D-1 TO D-2 U-1 TO U-4 PD-1 TO PD-4 SC-1 TO SC-7 WPC-1 TO WPC-4 IR-1 TO IR-4 PL-1 TO PL-3	LAYOUT CONSTRUCTION DETAILS DRAINAGE PLANS UTILITY PLANS PAVEMENT DELINEATION & SIGNING PLANS STAGE CONSTRUCTION—TRAFFIC HANDLING PLAN WATER POLLUTION CONTROL PLANS IRRIGATION PLANS

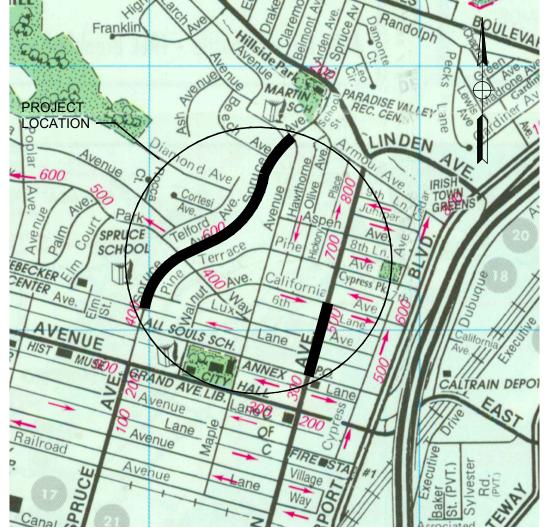

MAP SOURCE: COMPASS MAPS 2002

LOCATION MAP

ENGINEERING DIVISON APPROVED FOR BIDDING NOT FOR CONSTRUCTION Matthew Ruble

03/05/2020

BID SUBMITTAL ► MARK

N. ENG PROJECT No.: SJ-17123

LINDEN AVENUE PHASE 2 AND SPRUCE AVENUE TRAFFIC CALMING IMPROVEMENTS PROJECT - ATP

01 **—**OF **—** 56

REVISIONS



O WORK SHALL BE DONE ON THIS ITE UNTIL BELOW AGENCY IS NOTIFIED IF INTENTION TO GRADE OR EXCAVATE Underground Service Alert Call: TOLL FREE 1-800 642-2444

CITY OF SOUTH SAN FRANCISCO

PUBLIC WORKS DEPARTMENT 315 MAPLE AVENUE SOUTH SAN FRANCISCO, CA 94080

THOMAS 3000 OAK ROAD, SUITE 650 WALNUT CREEK, CA 94597 TEL: (925)938-0383

03/05/2020

NO SCALE

RA	MICHAEL K. COOPER 100
	Michael Cooper 03/05/2020
	RECISTERED CIVIL ENGINEER DATE

VICINITY MAP

AGGREGATE BASE

ASPHALT CONCRETE

AIR RELEASE VALVE

AGGREGATE SUBBBASE

BACKFLOW PREVENTER

BEGIN VERTICAL CURVE

CONTROLLED DENSITY BACKFILL

CAST-IN-PLACE CONCRETE PIPE

CITY OF SOUTH SAN FRANCISCO

CORRUGATED METAL PIPE

CEMENT TREATED BASE

END HORIZONTAL CURVE

EDGE OF TRAVELED WAY

ELECTROLYSIS TESTING STATION

FIRE DEPARTMENT CONNECTION

FINISHED GRADE ELEVATION

FULL DEPTH ASPHALT CONCRETE

END VERTICAL CURVE

BACK OF SIDEWALK

CATCH BASIN

CURB & GUTTER

COMMUNICATION

CAST IRON

BIOFILTRATION

BIKE LANE

BOULEVARD

BENCHMARK

BYPASS

BUFFER

CABLE

CLASS

CONCRETE

CONSTRUCT

CURB RAMP

CALTRANS

DRAIN INLET

ELECTROLIER

EDGE OF PAVEMENT

ELECTRICAL

ELEVATION

EASEMENT

EXISTING

EXCAVATION

FACE OF CURB

FIRE HYDRANT

FIBER OPTICS

FLOW LINE

COURT

DRIVE

DRIVEWAY

BEGIN HORIZONTAL CURVE

ASBESTO CEMENT PIPE

ABANDON

ADJUST

AVENUE

BEGIN

ANGLE POINT

FS

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R/W

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F/W,FOW

FIRE SERVICE

GAS LINE

GRADE BREAK

GATE VALVE

HANDICAPPED

HEADWALL

IRRIG, Irr IRRIGATION

GRADING PLANE

HORIZONTAL BEND

HOT MIX ASPHALT

INTERCONNECT/

INVERT OF PIPE

JOINT POLE

JOINT TRENCH

LINEAR FOOT

LAYOUT LINE

LOW POINT

LANDSCAPE

MAXIMUM

MEDIAN

MANHOLE

MINIMUM

MODIFIED

MONUMENT

PULL BOX

NOT IN CONTRACT

ORIGINAL GROUND

PORTLAND CEMENT CONCRETE/

POINT OF COMPOUND CURVE

POINT OF REVERSE CURVE

PUBLIC UTILITY EASEMENT

REINFORCED CONCRETE PIPE

POINT OF TANGENCY

PAVEMENT REINFORCING FABRIC

POINT OF REVERSE VERTICAL CURVE

POINT OF VERTICAL INTERSECTION

RECTANGULAR RAPID FLASHING BEACON

NOT TO SCALE

PROFILE GRADE

PROPERTY LINE

POWER POLE

PAVEMENT

RELOCATE

RETAINING

RIM ELEVATION

RIGHT OF WAY

REMOVE

RIGHT

RADIUS

ROAD

ROAD

LEFT

FACE OF SIDEWALK

HIGH DENSITY POLYETHYLENE

IRRIGATION CONTROLLER

HIGH PRESSURE/HINGE POINT/HIGH POINT

ETS

FDC

FG

FΗ

FL

FΟ

FDAC

F/C,FOC

REVISIONS			ROFESSIONAL COOPER
DESCRIPTION	DATE	BY	WICHAEL K COORED (2)
			(No. <u>29072</u>) ∰
			Exp. 3/31/2021
			STATE OF CALIFORNIA
			Michael Cooper 03/05/2020
			REGISTERED CIVIL ENGINEER DATE



CITY OF SOUTH SAN FRANCISCO PUBLIC WORKS DEPARTMENT

SC,S/C

SD

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SSCO

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VC

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WM

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Trans

SAWCUT

SHEET

STREET

STATION(S)

TOP OF CURB

TOP OF GRATE

TRAFFIC SIGNAL

STANDARD

SIDEWALK

TELEPHONE

TRANSITION

UNDERGROUND

VERTICAL CURVE

VALLEY GUTTER

WATER SERVICE

WATER METER

TYPICAL

VARIES

STORM DRAIN

STORM DRAIN MANHOLE

SANITARY SEWER CLEANOUT

SANITARY SEWER MANHOLE

TEMPORARY CONSTRUCTION EASEMENT

SAN MATEO COUNTY

SANITARY SEWER

315 MAPLE AVENUE 300 SOUTH SAN FRANCISCO, CA 94080 WAL

► MARK

BID SUBMITTAL

DESIGNED BY: R. OYEWOLE DATE: 03/05/2020

LINDEN AVENUE PHASE 2 AND SPRUCE AVENUE TRAFFIC CALMING IMPROVEMENTS PROJECT - ATP ABBREVIATION-LEGEND-SURVEY CONTROL

NO SCALE

(1- | SHEET

02 ___OF ___ 56

I E THOMAS	DRAWN BY:	J. SORIA
O OAK ROAD, SUITE 650		
LNUT CREEK, CA 94597	PROJECT No.:	SJ-17123
TEL: (925)938-0383		/ /

WATER

WATER

EAD FIBER OPTIC	D-3	STANDARD CATCH BASIN-TYPES GO-SSFT	
IMED WATER LINE	D-4	STANDARD CATCH BASIN-TYPES GTO AND GTO-	-SSF
TRENCH	D-5	CURB DRAIN DETAIL	
HYDRANT	D-6	TYPICAL BEHIND SIDEWALK SUBDRAIN DETAIL	L
ALVE	D-7	BUBBLER BOX DRAIN OUTLET	
LE	SS-1	STANDARD SEWER LATERAL	
CLEAN OUT	SS-2	STANDARD SEWER LATER CLEANOUT	
GROUND TRANSFORMER	SS-3	SEWER LATERAL REPLACEMENT AT CROSSING	
TY POLE	E-1	STANDARD ALUMINUM ELECTROLIER	
METER	E-2	COLOR CODE FOR LOOPS	
VALVE	MISC-1	WOOD FENCE POST, REAR PROPERTY CORNER I	MONUMENT
		THE SAME	ENGINEERING DIVISON APPROVED FOR BIDDING

CURB, GUTTER, SIDEWALK & DRIVEWAY APPROACHES PG&E ELECTRICAL LINE R-2STANDARDS FOR SIDEWALK REPAIR PG&E GAS LINE R-3PRIVATE STREET INTERSECTING A PUBLIC STREET CITY SEWER LINE R-4 TYPICAL UTILITY TRENCH DETAIL STORM DRAINAGE LINE R-5 TRENCH REPAIR-PCC PAVEMENT AND PAVEMENT REINFORCING FABRIC TELECOMMUNICATION R-6 ROCKWHEEL TRENCH REPAIR TELEPHONE LINE R-7FREESTANDING CURB 6" & 8' WATER LINE R-8 SURVEY MONUMENTS FIBER OPTICS LINE R-9 ADJUSTING MONUMENT/MANHOLE TO GRADE OVERHEAD ELECTRICAL R-10 WEDGE CUT AND AC OVERLAY DETAILS OVERHEAD TELECOMMUNICATION D-1 STANDARDS FOR PRECAST MANHOLE OVERHEAD TELEPHONE D-2STANDARD CATCH BASIN OVERHEAD FIBER OPTIC RECLAI JOINT FIRE H GAS VA MANHOL SEWER UNDERG UTILIT

LEGEND:

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PROPOSED

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COSSF STANDARDS FOR PUBLIC IMPROVEMENTS:

EXISTING

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DESCRIPTION

SUTH SAV	ENGINEERING DIVISON APPROVED FOR BIDDING NOT FOR CONSTRUCTION
	By: Matthew Ruble
LIFORNI	Date: 03/05/2020


- 2. DIMENSIONS OF THE PAVEMENT STRUCTURAL SECTIONS ARE SUBJECT TO TOLERANCES SPECIFIED IN THE CALTRANS 2015 Std SPECIFICATIONS.
- 3. REFER TO LAYOUT PLANS FOR LOCATIONS OF CURB AND GUTTER, CURB AND SIDEWALK, COLD PLANE, OVERLAY LIMITS, AND SAWCUT LIMITS.
- 4. FOR CURB AND GUTTER, SIDEWALK AND DRIVEWAY DETAILS SEE COSSF Std DRAWING No. R-1.


TYPICAL PAVEMENT STRUCTURAL SECTIONS

COLD PLANE AC Pvmt 2"
2" Min HMA (TYPE A)


2 10" HMA (TYPE A) & 2" OVERLAY

3 4" PCC 6" CI 2 AB

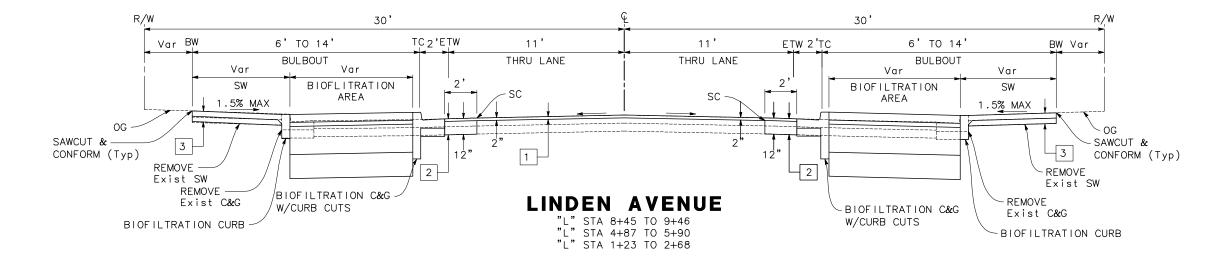

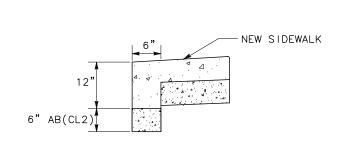

BIOFILTRATION CURB DETAIL

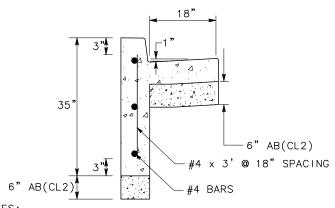

NOTES:
1. SEE COSSF STANDARD DRAWING NO. R-1 FOR OTHER INFORMATION NOT SHOWN.

2. SEE PL- FOR BIOFILTRATION PLANTER INLET & OUTLET DETAIL.

BIOFILTRATION CURB



ENGINEERING DIVISON
APPROVED FOR BIDDING
NOT FOR CONSTRUCTION
By: Matthew Ruble
Date: 03/05/2020

	REVISIONS					
NO.	DESCRIPTION	DATE	BY			



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Underground Service Alert

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642-2444

TWO WORKING DAYS BEFORE YOU DIG

CITY OF SOUTH SAN FRANCISCO

PUBLIC WORKS DEPARTMENT
315 MAPLE AVENUE
SOUTH SAN FRANCISCO, CA 94080

MARK THOMAS 3000 OAK ROAD, SUITE 650 WALNUT CREEK, CA 94597

TEL: (925)938-0383

BID SUBMITTAL

DESIGNED BY:	S. LEE	
DRAWN BY:	J. SORIA	
CHECKED BY:	M. COOPER	
PROJECT No.:	SJ-17123	
DATE:	03/05/2020	


LINDEN AVENUE PHASE 2 AND SPRUCE AVENUE TRAFFIC CALMING IMPROVEMENTS PROJECT - ATP LINDEN AVENUE TYPICAL SECTIONS

NO SCALE

X-1

REVISIONS

DESCRIPTION

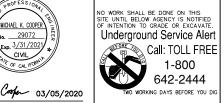







TEL: (925)938-0383


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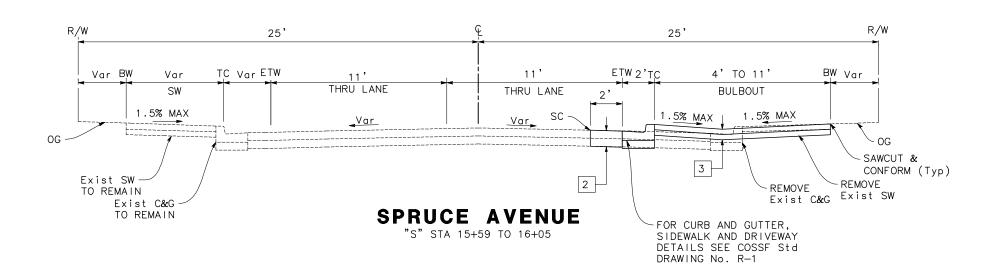
DESIGNED BY:	S. LEE
DRAWN BY:	N. ENG
CHECKED BY:	M. COOPER
PROJECT No.:	SJ-17123
DATE:	03/05/2020

SPRUCE AVENUE

NO SCALE

LINDEN AVENUE PHASE 2 AND SPRUCE AVENUE TRAFFIC CALMING IMPROVEMENTS PROJECT - ATP TYPICAL SECTIONS



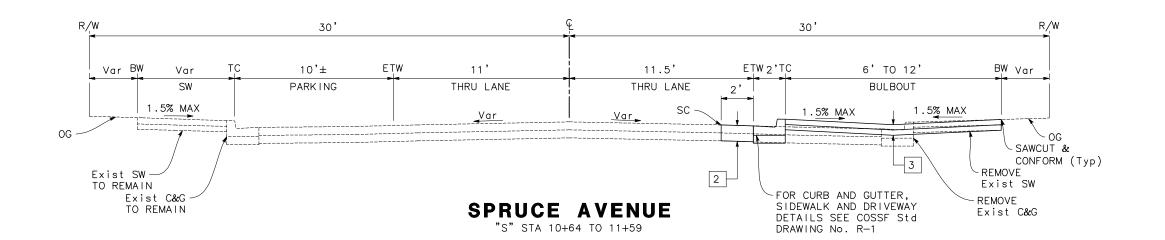

STII SAN SE	API	GINEERING PROVED FOR	BIDDING
S THE SHIP S	NO.	FOR CONS	FRUCTION
E nano S	By:	Matthew	Ruble
CALIFORNIA	Date:_	03/05/	2020

SHEET

04

—oF—

56

REVISIONS

DESCRIPTION











DESIGNED BY:	S. LEE
DRAWN BY:	N. ENG
CHECKED BY:	M. COOPER
PROJECT No.:	SJ-17123
DATE:	03/05/2020

BID SUBMITTAL

DRAWING No. R-1


LINDEN AVENUE PHASE 2 AND SPRUCE AVENUE TRAFFIC CALMING IMPROVEMENTS PROJECT - ATP SPRUCE AVENUE TYPICAL SECTIONS

NO SCALE

SHEET 05 ---OF---56

X-3


R/W	30'±	<u>€</u>	30'±	R/W
Var BW Var SW Var	TC Var THRU LANE	iii	Var ETW 2'T THRU LANE Var SC	C Var BW Var SIDEWALK 1.5% MAX J OG SAWCUT & CONFORM (Typ)
Exist SW TO REMAIN Exist C&G TO REMAIN		SPRUCE AVENUE "S" STA 33+69 TO 33+86		REMOVE Exist SW REMOVE Exist C&G FOR CURB AND GUTTER, SIDEWALK AND DRIVEWAY DETAILS SEE COSSF Std

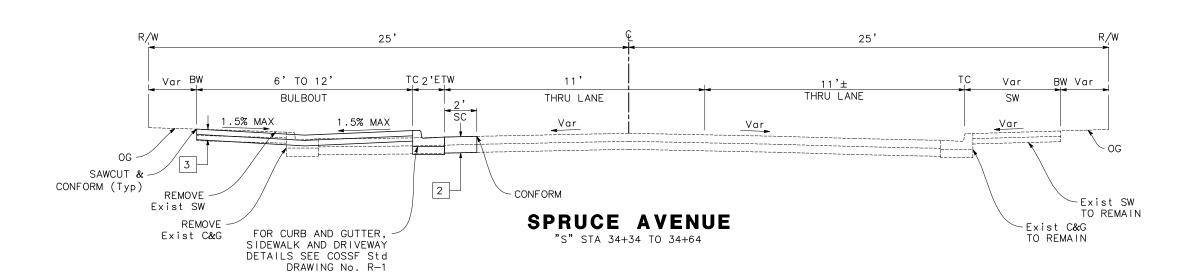



REVISIONS

DESCRIPTION

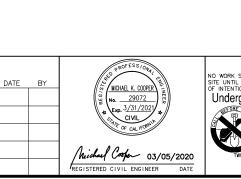

DM-1

L-1 D-1U-1 PD-1 SC-1 SC-5 WPC-1



1+00

CITY OF SOUTH PUBLIC WORKS

LINDEN AVE

3+00

"L" LINE

4+00

315 MAPL SOUTH SAN FRANCISCO, CA 94080

MARK		
■ ■ THOMAS		
3000 OAK ROAD, SUITE 650		
WALNUT CREEK, CA 94597		
TEL: (925)938-0383		

DM-2

L-2 D-2 U-2 PD-2 SC-2 SC-6

WPC-2

7+00

BID SU	BMITTAL
DESIGNED BY:	R. OYEWOLE

8+00

DESIGNED BY:	R. OYEWOLE
DRAWN BY:	J. SORIA
CHECKED BY:	M. COOPER
PROJECT No.:	SJ-17123
DATE:	03/05/2020

LINDEN AVENUE PHASE	2	AND
SPRUCE AVENUE TRAFFIC	$\mathbf{C}\mathbf{A}$	LMIN
IMPROVEMENTS PROJECT	_	ATF
LINDEN AVENUE		
KEY MAP		

NG	K-
Р	SHEET
	06
	—oF—

ENGINEERING DIVISON APPROVED FOR BIDDING NOT FOR CONSTRUCTION

By: Matthew Ruble

H SAN FRANCISCO	► MARK	В
S DEPARTMENT		DES
LE AVENUE	■ ■ THOMAS	DRA
NCISCO CA 94080	13000 OAK ROAD. SUITE 650	CHE


	Date: 03	/05/2020
SUBMITTAL	LINDEN AVENUE PHASE 2 AND SPRUCE AVENUE TRAFFIC CALMING	K-1
NED BY: R. OYEWOLE	IMPROVEMENTS PROJECT - ATP	SHEET
N BY: J. SORIA	LINDEN AVENUE	06
KED BY: M. COOPER	KEY MAP	06

10+00

LINDEN AVENUE	SHEET
KEY MAP	06
	—OF —
NO SCALE	56

3+00 MILLER AVE	3+00 LUX AVE	SHOO SHOO SHOO SHOO SHOO SHOO SHOO SHOO	
	KEY MAP No scale		



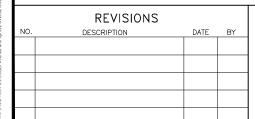

DM-3 L-3 U-3 PD-3 SC-3 SC-7 WPC-3





PARK WAY

CITY OF SOUTH SAN FRANCISCO

315 MAPLE AVENUE SOUTH SAN FRANCISCO, CA 94080

►⊿ MARK THOMAS 3000 OAK ROAD, SUITE 650 WALNUT CREEK, CA 94597

TEL: (925)938-0383

23+00 24+00 25+00

BID SUBMITTAL

DESIGNED BY:	R. OYEWOLE
DRAWN BY:	J. SORIA
CHECKED BY:	M. COOPER
PROJECT No.:	SJ-17123
DATE:	03/05/2020

LINDEN AVENUE PHASE 2 AND
SPRUCE AVENUE TRAFFIC CALMIN
IMPROVEMENTS PROJECT - ATP
SPRUCE AVENUE
KEY MAP

ENGINEERING DIVISON APPROVED FOR BIDDING NOT FOR CONSTRUCTION

Matthew Ruble 03/05/2020

DM-4 L-4 U-4

PD-4 SC-4 WPC-4

PUBLIC WORKS DEPARTMENT


KEY MAP NO SCALE

22+00


DESIGNED BY:	R. OYEWOLE
DRAWN BY:	J. SORIA
CHECKED BY:	M. COOPER
PROJECT No.:	SJ-17123

NO SCALE

SHEET
07
— OF —
56

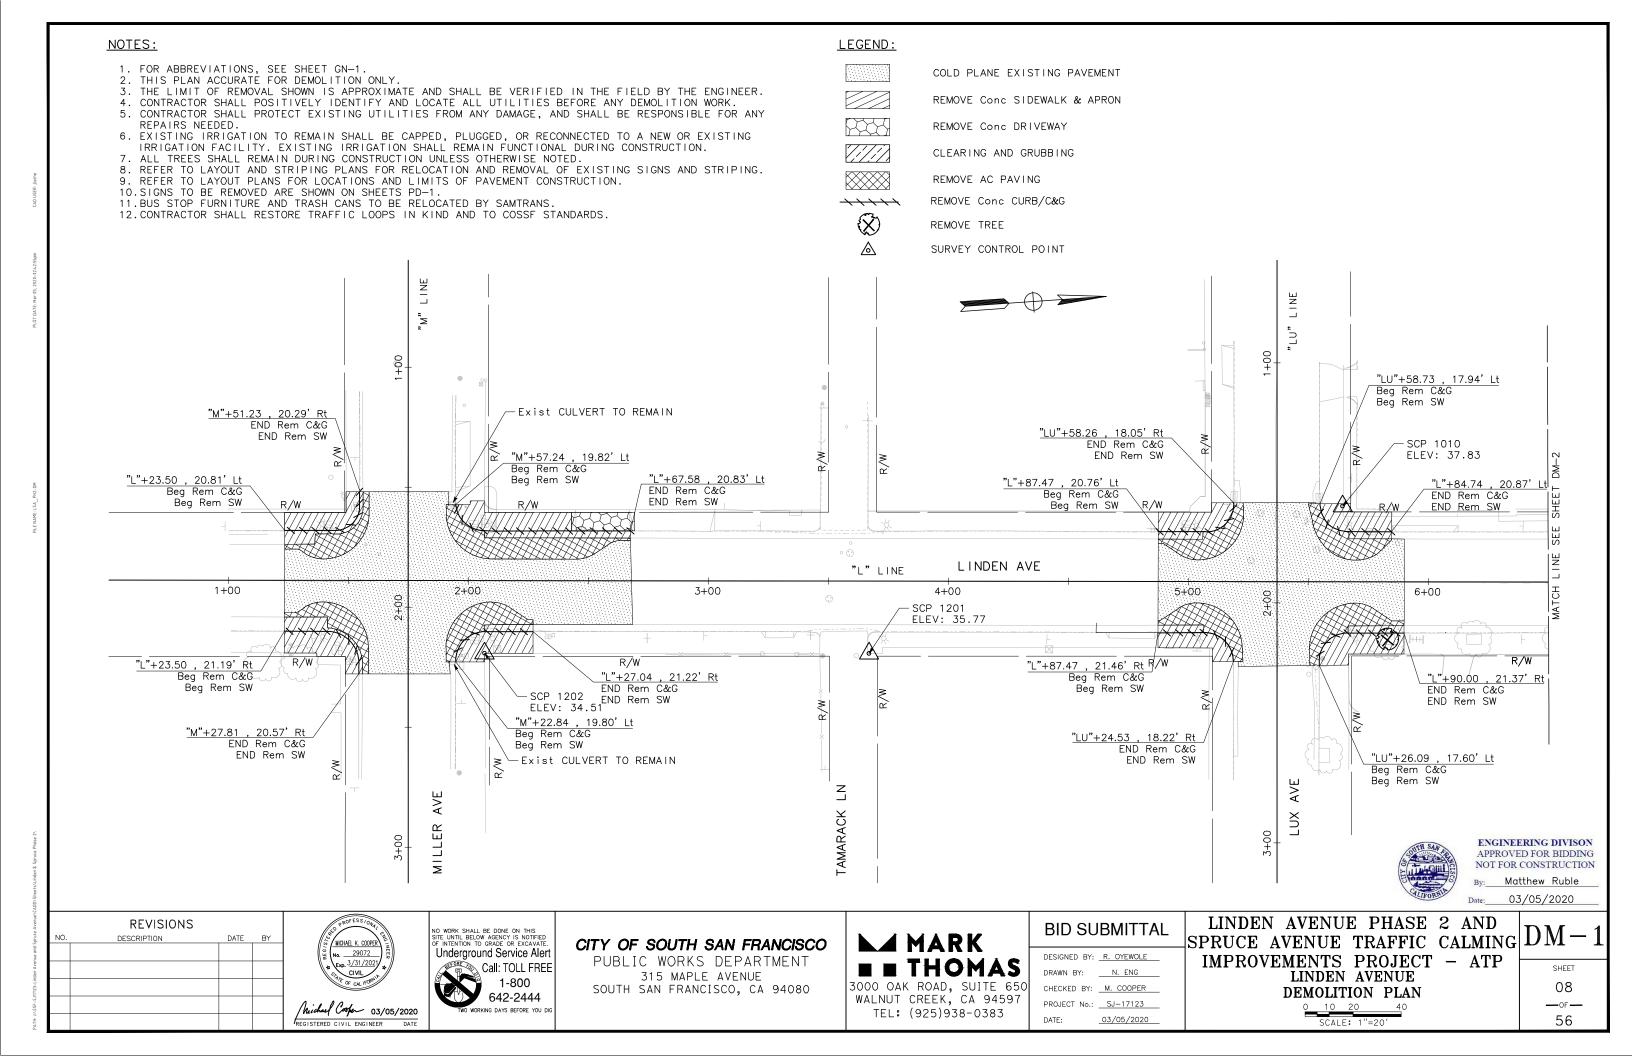

FOR NOTES AND LEGEND, SEE SHEET DM-1.

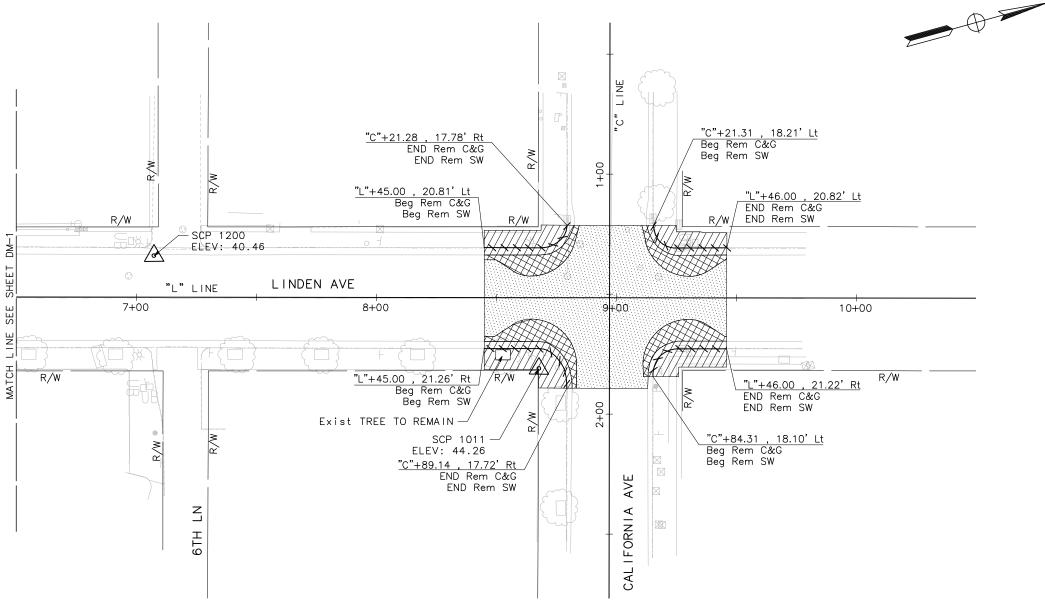



ENGINEERING DIVISON APPROVED FOR BIDDING NOT FOR CONSTRUCTION By: Matthew Ruble 03/05/2020

REVISIONS					
DESCRIPTION	DATE	BY			

MICHAEL K. COOPER No. 29072 Exp. 3/31/2021 Michael Cooper 03/05/2020 REGISTERED CIVIL ENGINEER DATE

no work shall be done on this site until below agency is notified of intention to grade or excavate. Underground Service Alert Call: TOLL FREE
1-800
642-2444

CITY OF SOUTH SAN FRANCISCO

PUBLIC WORKS DEPARTMENT 315 MAPLE AVENUE SOUTH SAN FRANCISCO, CA 94080

►⊿ MARK **THOMAS** 3000 OAK ROAD, SUITE 650 WALNUT CREEK, CA 94597

TEL: (925)938-0383


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DESIGNED BY:	R. OYEWOLE
DRAWN BY:	N. ENG
CHECKED BY:	M. COOPER
PROJECT No.:	SJ-17123
DATE:	03/05/2020

LINDEN AVENUE PHASE 2 AND SPRUCE AVENUE TRAFFIC CALMING DM-2 IMPROVEMENTS PROJECT - ATP LINDEN AVENUE **DEMOLITION PLAN**


0 10 20 SCALE: 1"=20'

09 —oг— 56

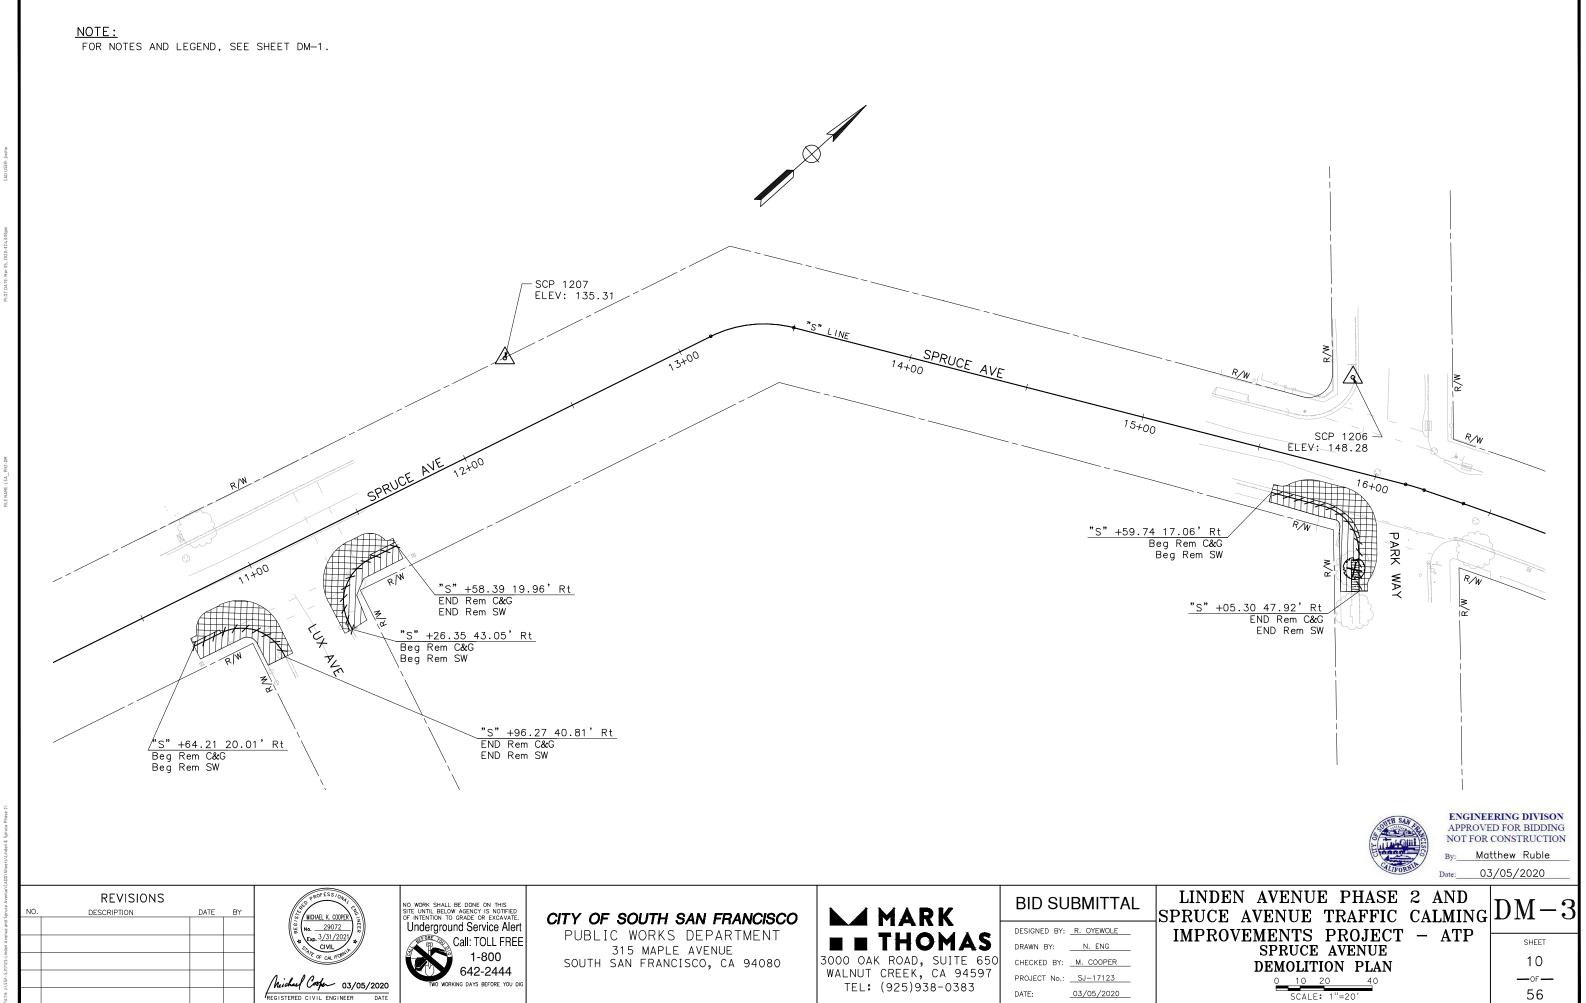

REGISTERED CIVIL ENGINEER DATE

FOR NOTES AND LEGEND, SEE SHEET DM-1.

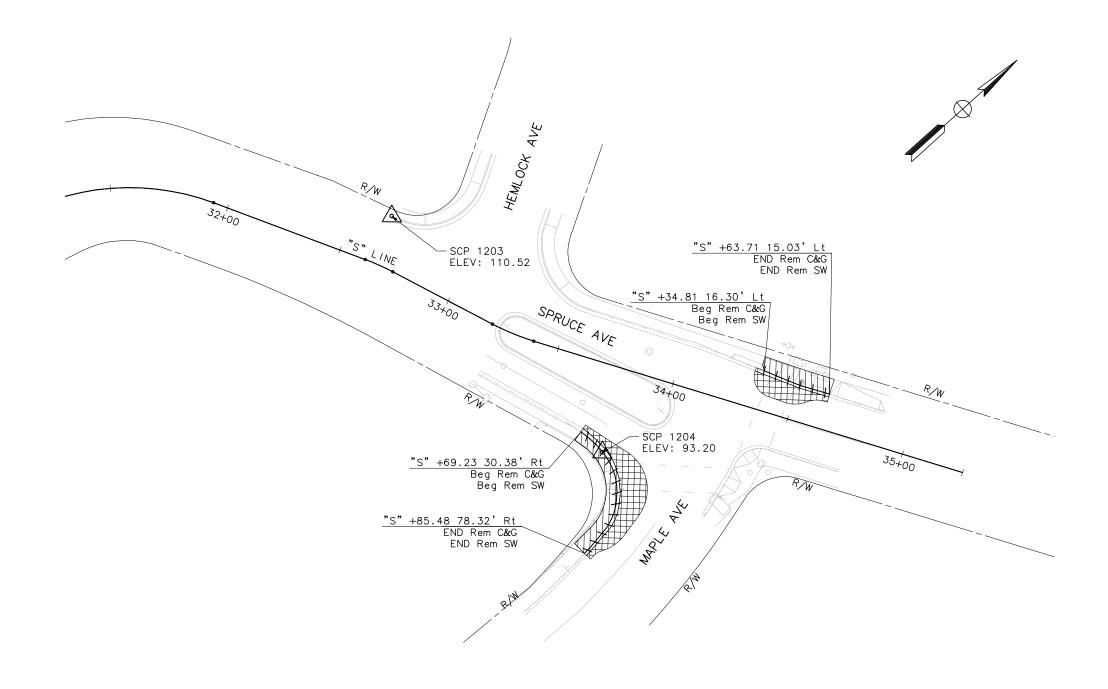



ENGINEERING DIVISON APPROVED FOR BIDDING NOT FOR CONSTRUCTION By: Matthew Ruble Date: 03/05/2020

l	REVISIONS				
NO.	DESCRIPTION	DATE	BY		
l					



NO WORK SHALL BE DONE ON THIS SITE UNTIL BELOW AGENCY IS NOTIFIED OF INTENTION TO GRADE OR EXCAVATE.

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CITY OF SOUTH SAN FRANCISCO

PUBLIC WORKS DEPARTMENT 315 MAPLE AVENUE SOUTH SAN FRANCISCO, CA 94080

►⊿ MARK **THOMAS** 3000 OAK ROAD, SUITE 650 WALNUT CREEK, CA 94597

TEL: (925)938-0383

	BID SUBMITTAL		
I	DESIGNED BY: _	R. OYEWOLE	
l	DRAWN BY: _	N. ENG	
ا	CHECKED BY: _	M. COOPER	


DESIGNED BY:	R. OYEWOLE	Τλ
DRAWN BY:	N. ENG	111
CHECKED BY:	M. COOPER	
PROJECT No.:	SJ-17123	
DATE:	03/05/2020	

LINDEN AVENUE PHASE 2 AND SPRUCE AVENUE TRAFFIC CALMIN MPROVEMENTS PROJECT - ATP SPRUCE AVENUE


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	SCAL	F: 1"=2	0'	

G	DM-4
	SHEET

11 ---OF---56

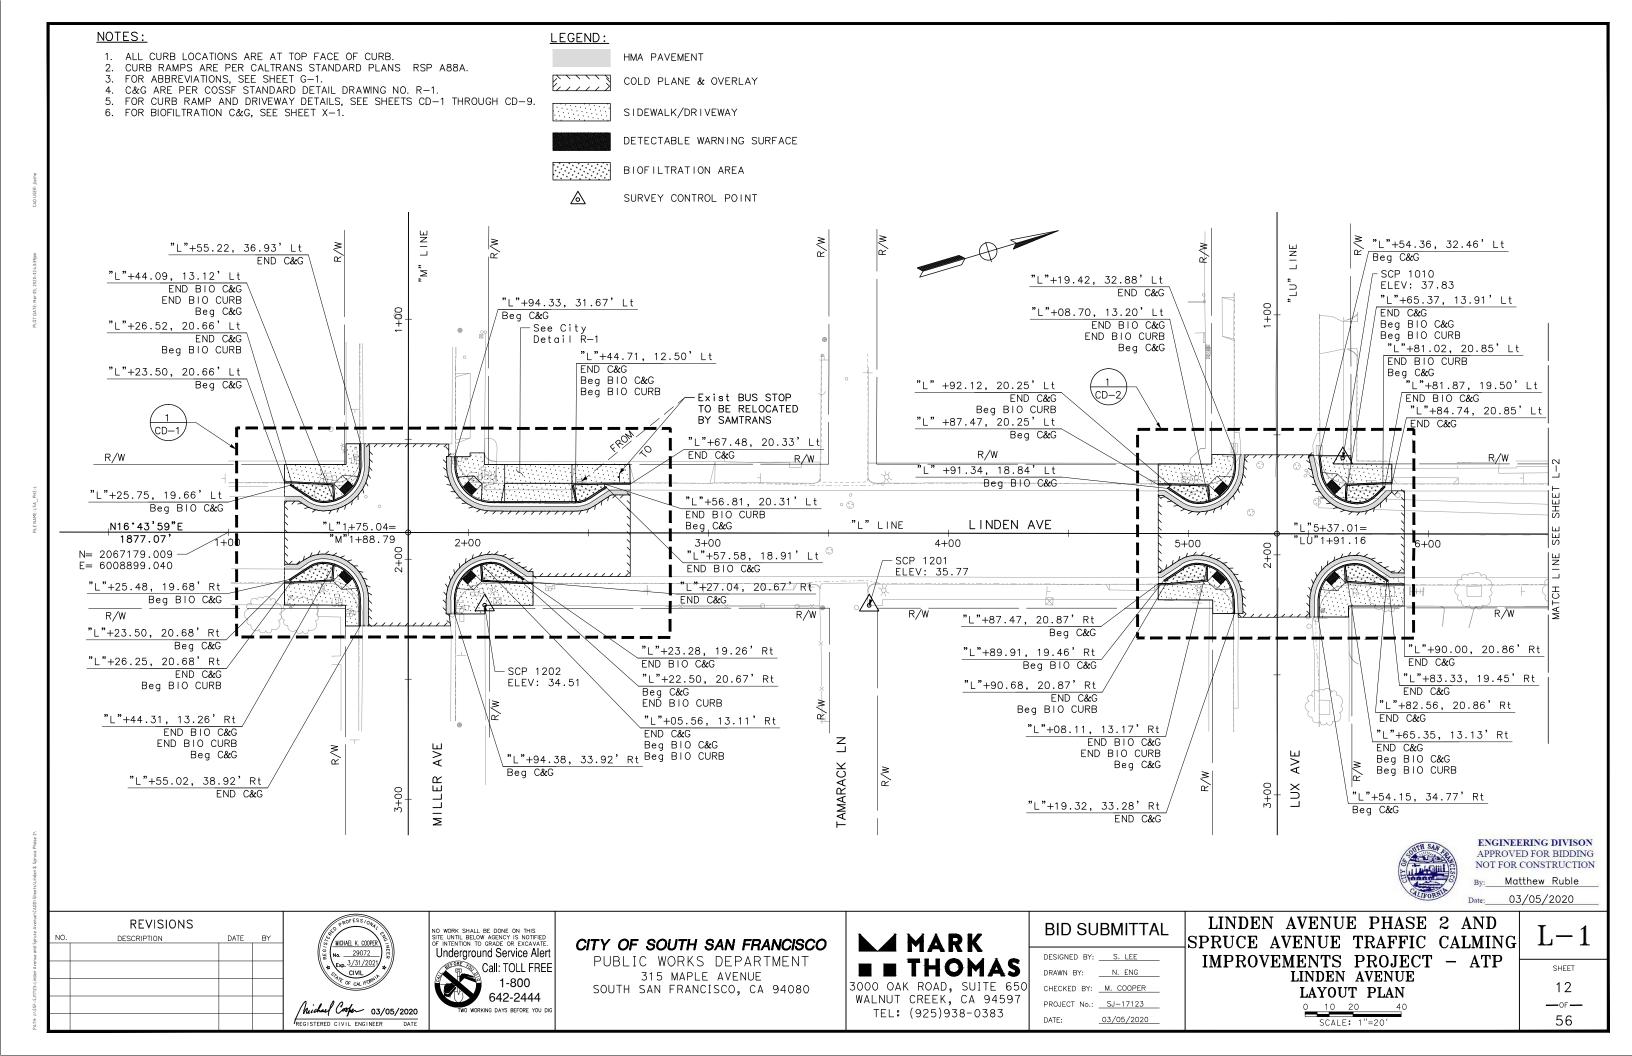

FOR NOTES AND LEGEND, SEE SHEET L-1.

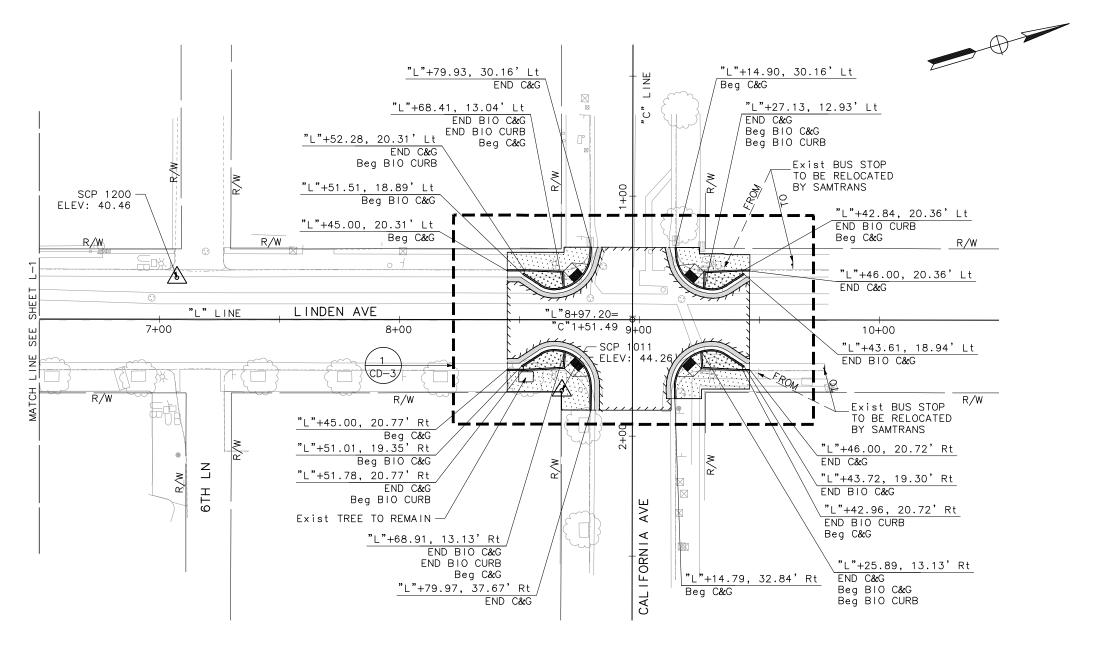



REVISIONS DESCRIPTION





CITY OF SOUTH SAN FRANCISCO

PUBLIC WORKS DEPARTMENT 315 MAPLE AVENUE SOUTH SAN FRANCISCO, CA 94080

MARK 3000 OAK ROAD, SUITE 650 WALNUT CREEK, CA 94597

TEL: (925)938-0383

BID SU	BMITTAL
DESIGNED BY:	S. LEE
DRAWN BY:	N. ENG

CHECKED BY: M. COOPER


PROJECT No.: SJ-17123

03/05/2020

LINDEN AVENUE PHASE	2	AND	
SPRUCE AVENUE TRAFFIC	$\mathbf{C}\mathbf{A}$	LMIN	G
IMPROVEMENTS PROJECT	_	ATP	
LINDEN AVENUE			
LAYOUT PLAN			
<u>0 10 20 4</u> 0			
SCALE: 1"=20'			

7	L-	2
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SHEET 13 —OF — 56



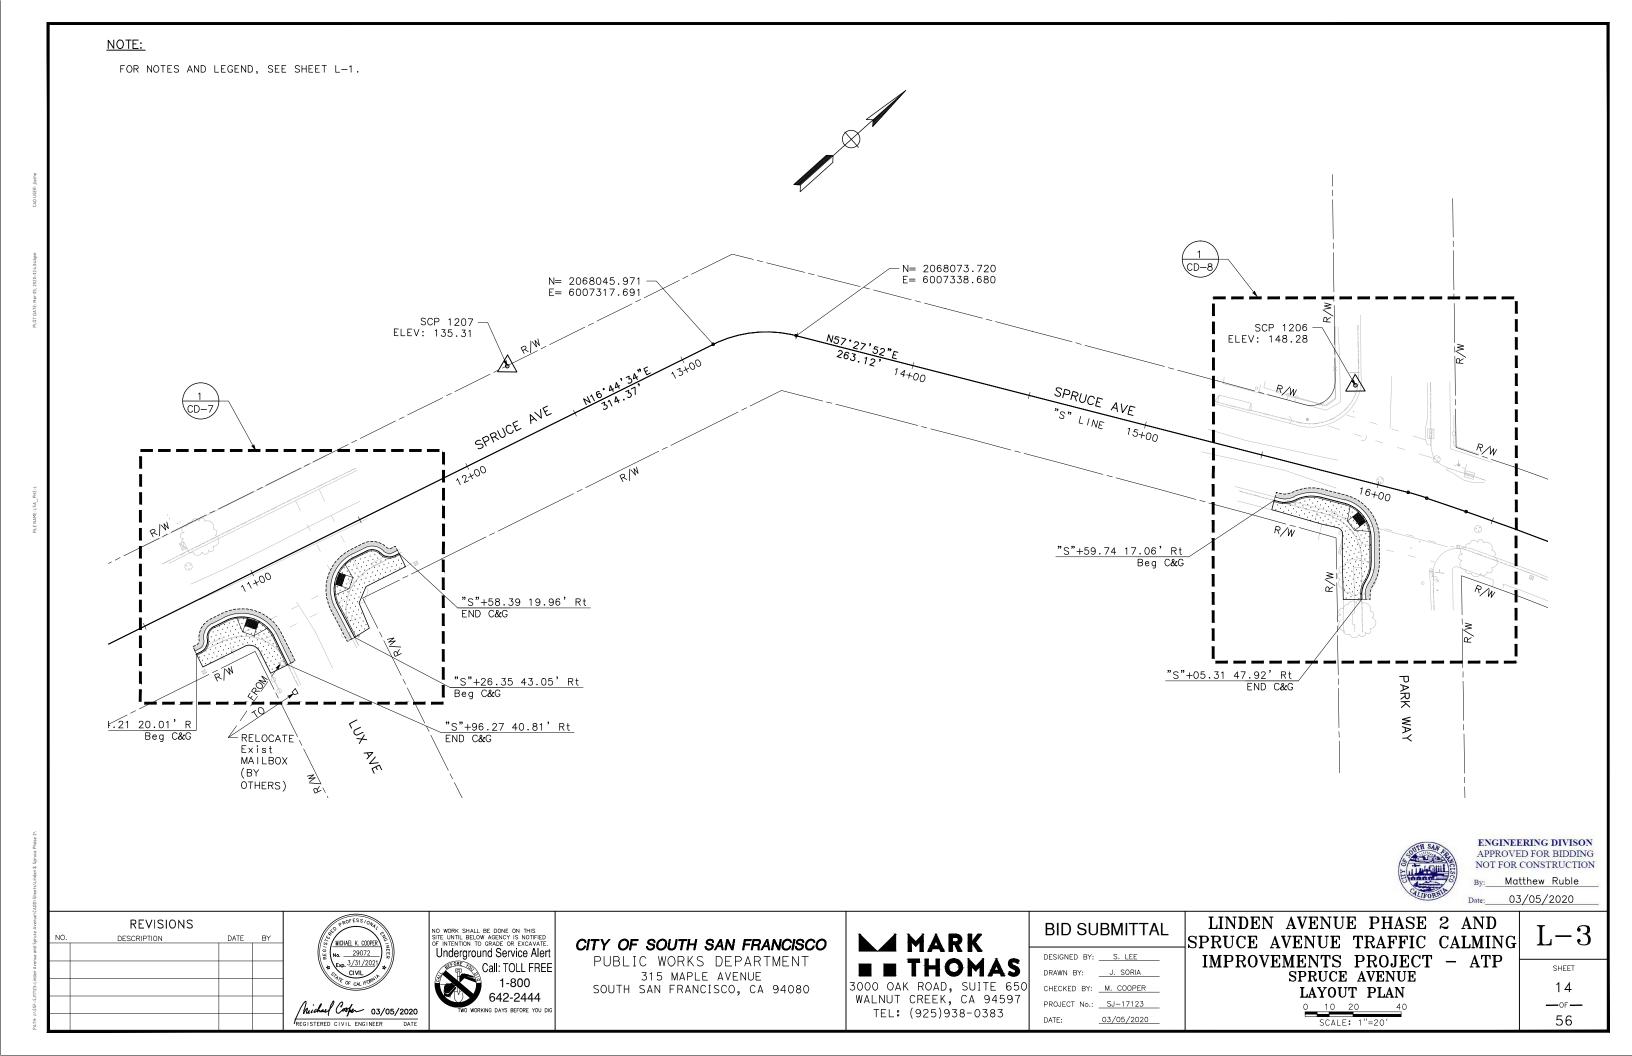

REVISIONS DESCRIPTION

MICHAEL K. COOPER
No. 29072
Exp. 3/31/2021 Michael Cooper 03/05/2020
REGISTERED CIVIL ENGINEER DATE

NO WORK SHALL BE DONE ON THIS SITE UNTIL BELOW AGENCY IS NOTIFIED OF INTENTION TO GRADE OR EXCAVATE.

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CITY OF SOUTH SAN FRANCISCO

PUBLIC WORKS DEPARTMENT 315 MAPLE AVENUE SOUTH SAN FRANCISCO, CA 94080

MARK ■ THOMAS 3000 OAK ROAD, SUITE 650 WALNUT CREEK, CA 94597


TEL: (925)938-0383


BID SUBMITTAL


DESIGNED BY:	S. LEE
DRAWN BY:	J. SORIA
CHECKED BY:	M. COOPER
PROJECT No.:	SJ-17123
DATE:	03/05/2020


LINDEN AVENUE PHASE 2 AND SPRUCE AVENUE TRAFFIC CALMING IMPROVEMENTS SPRUCE LAYOUT


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ENTS PROJECT - ATP	SHEET
PRUCE AVENUE LAYOUT PLAN	15
0 10 20 40	—OF —
SCALE: 1"=20'	56

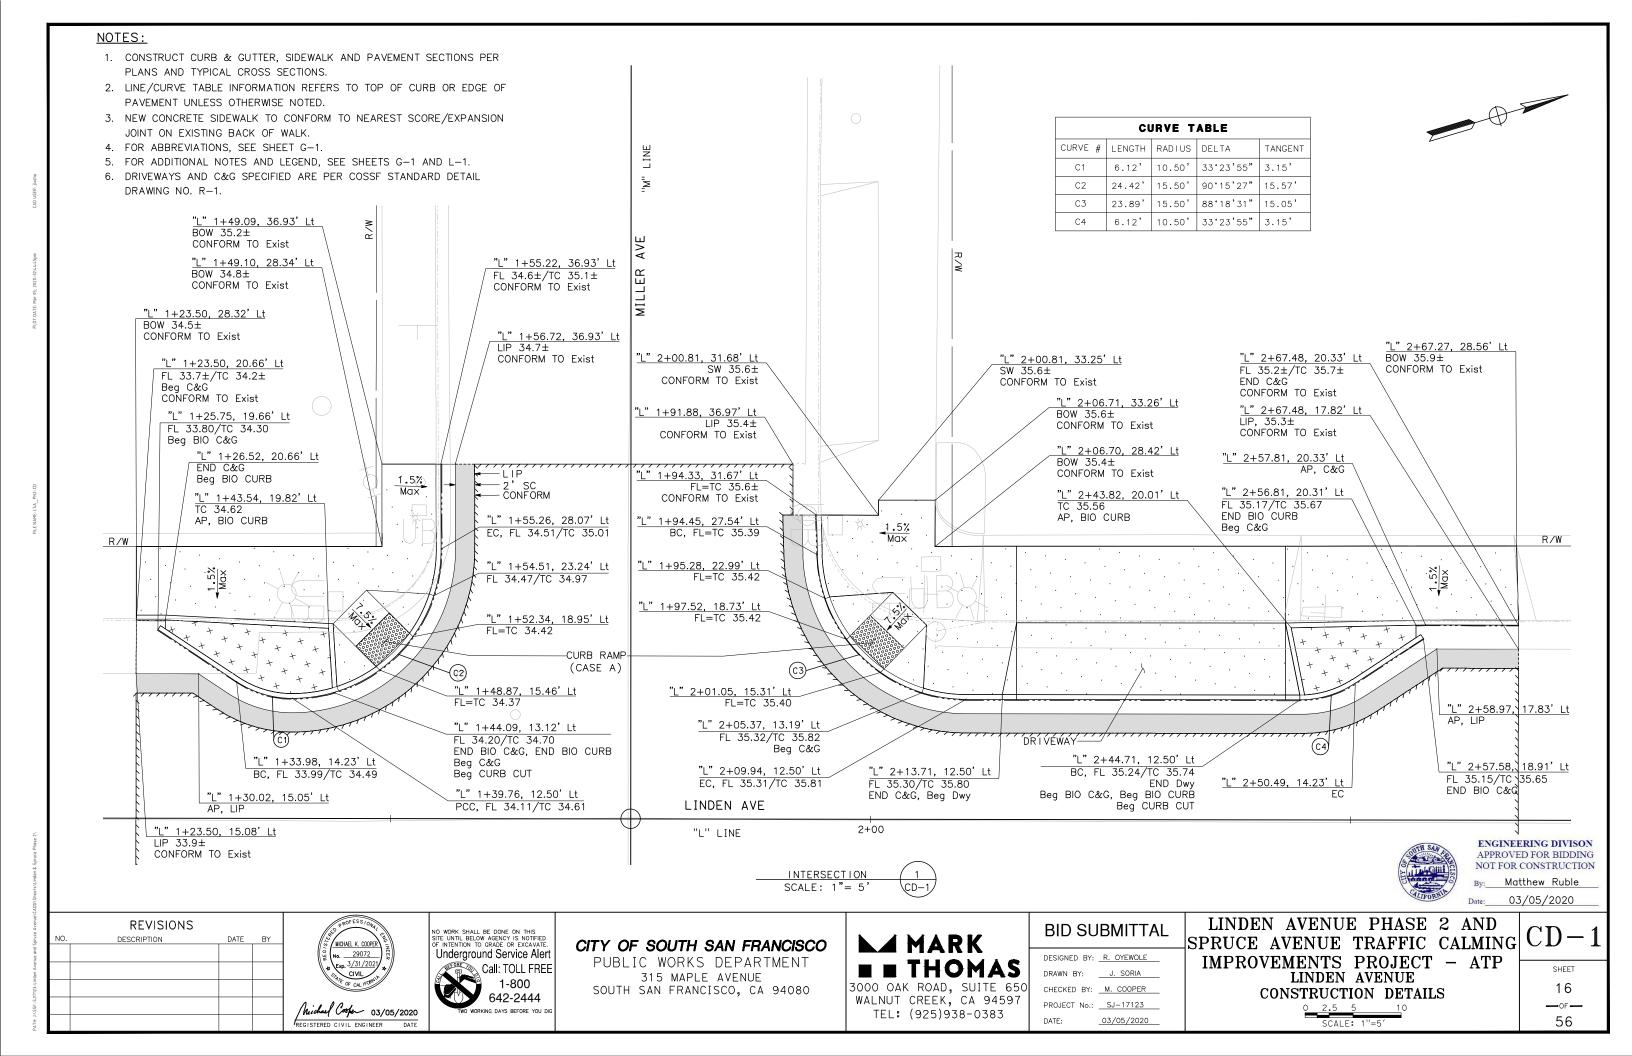


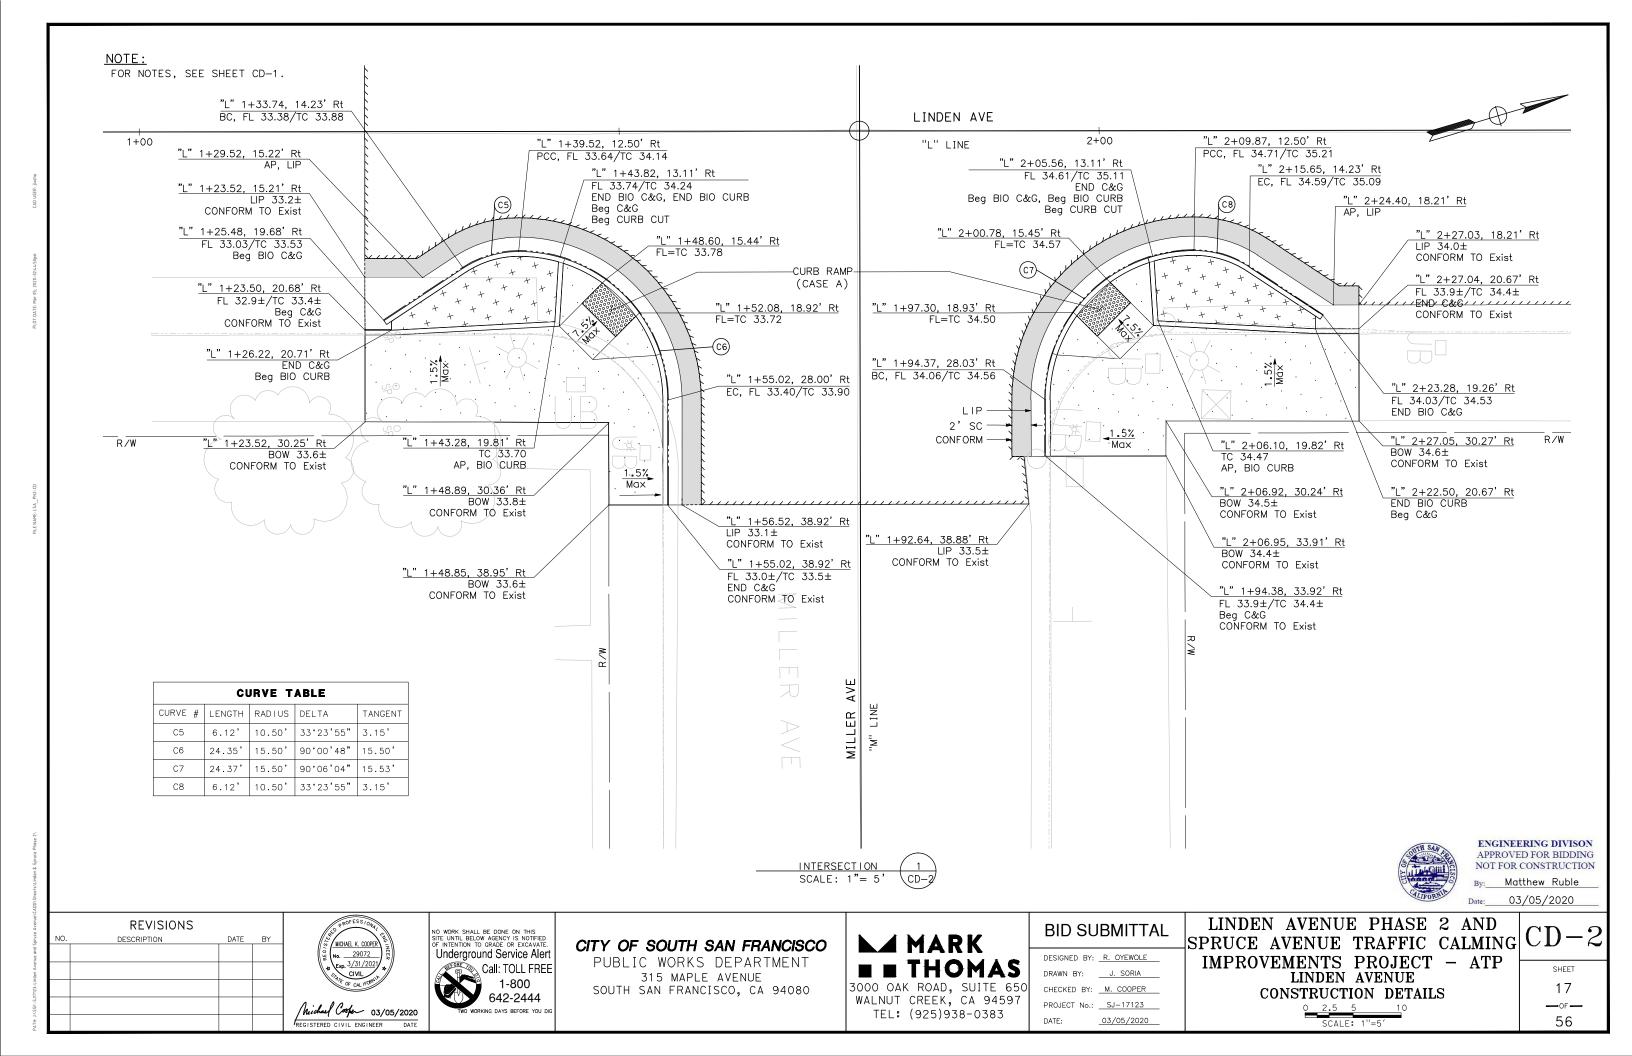


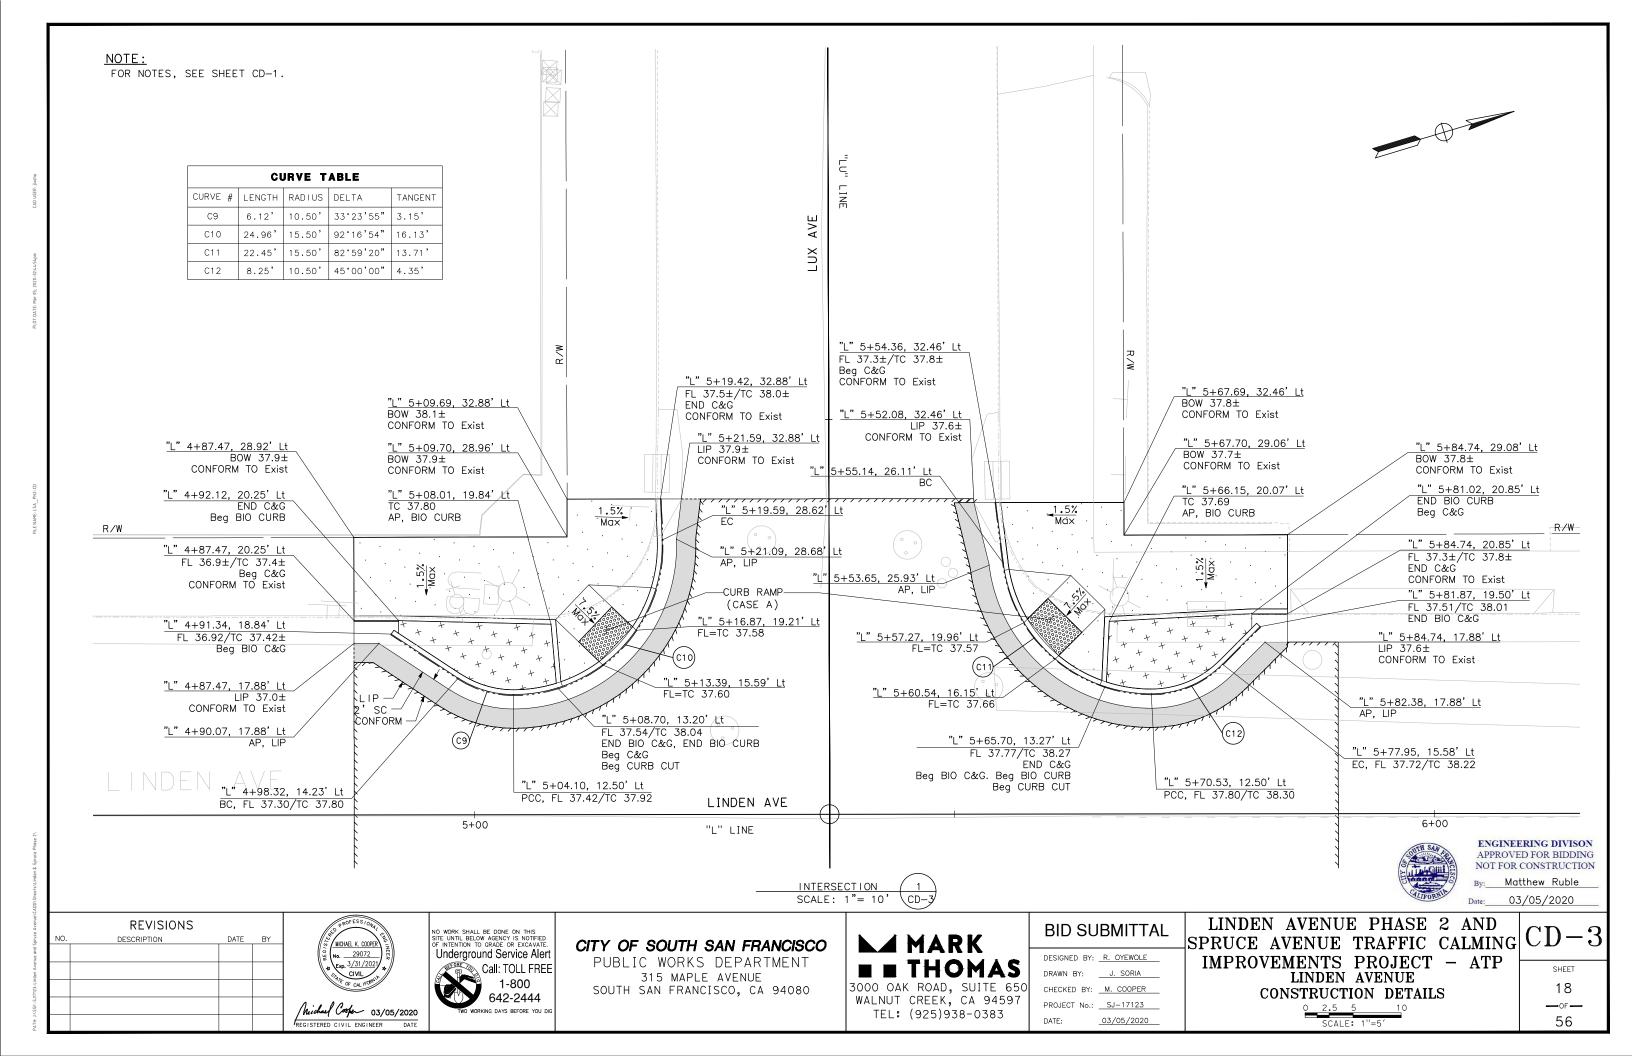


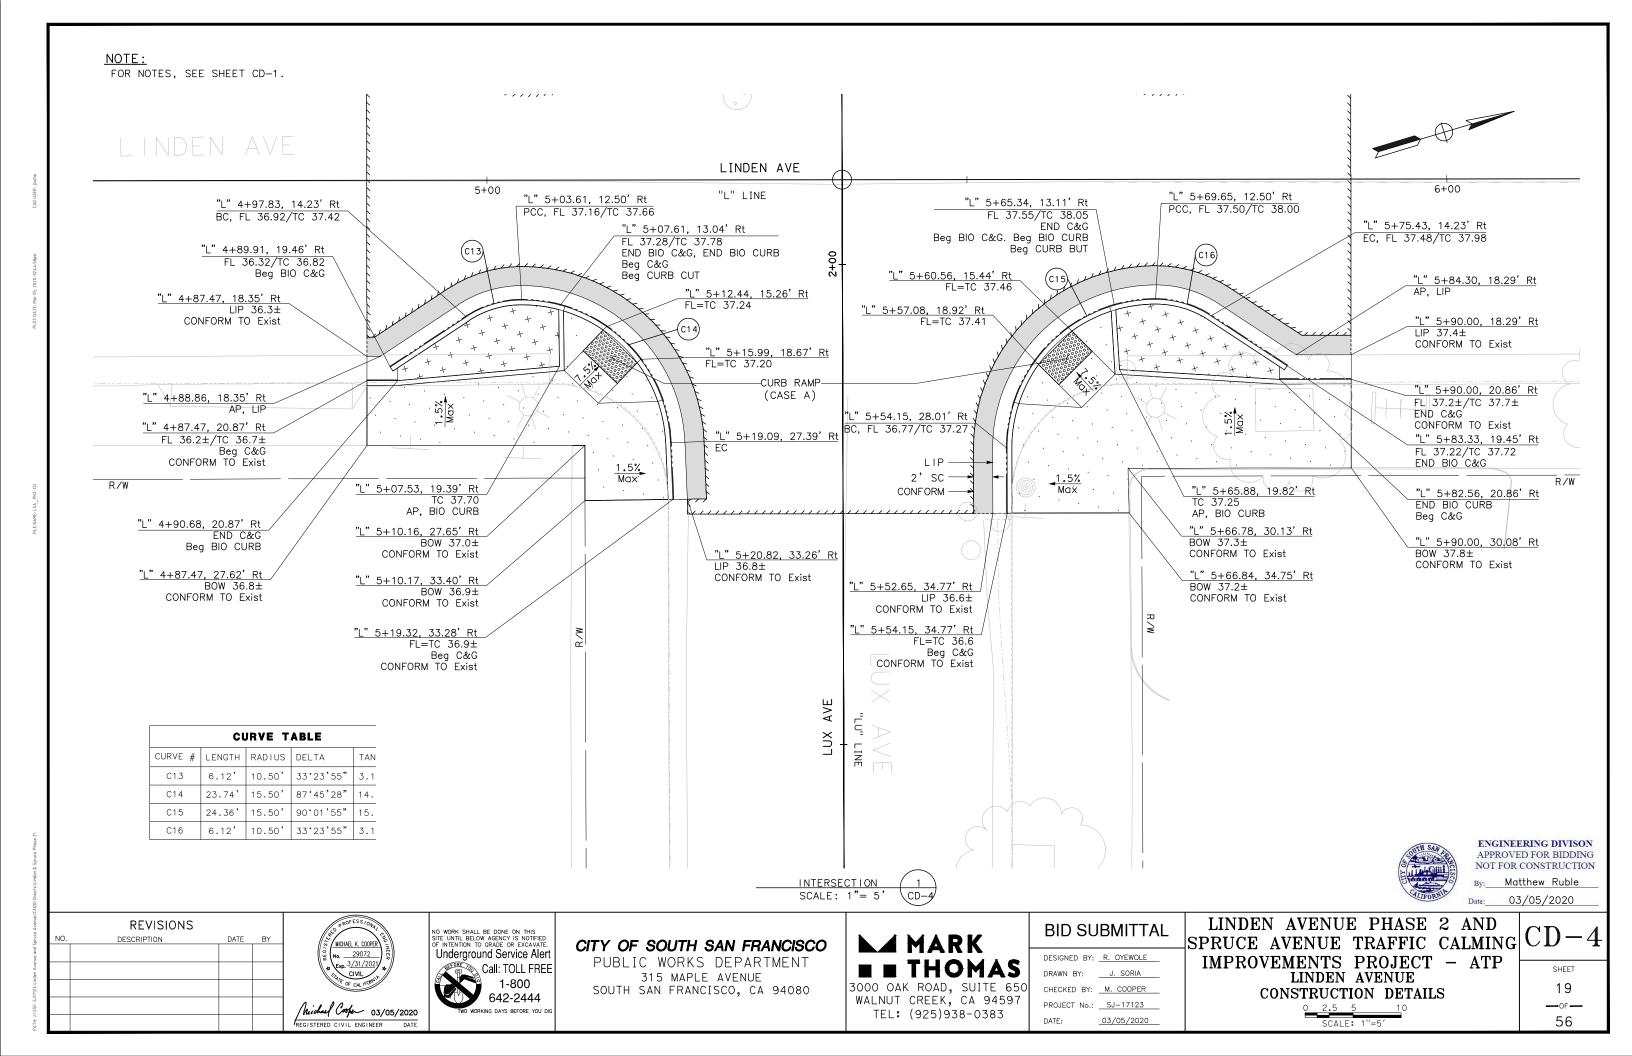

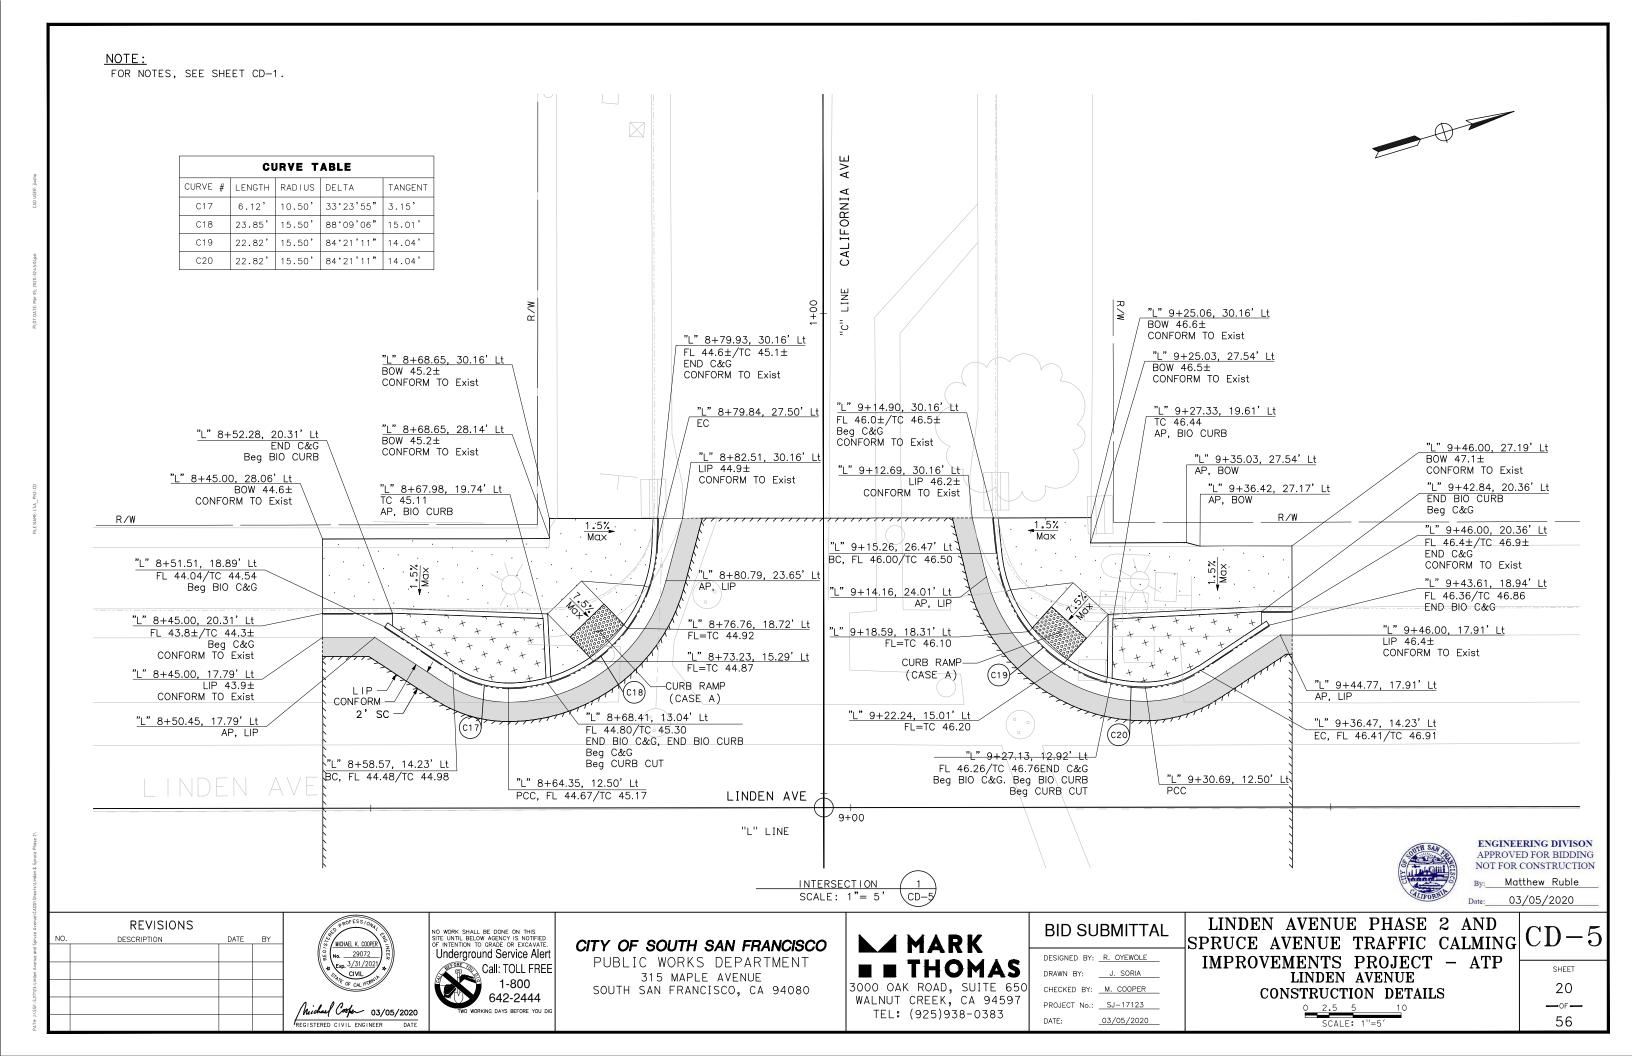

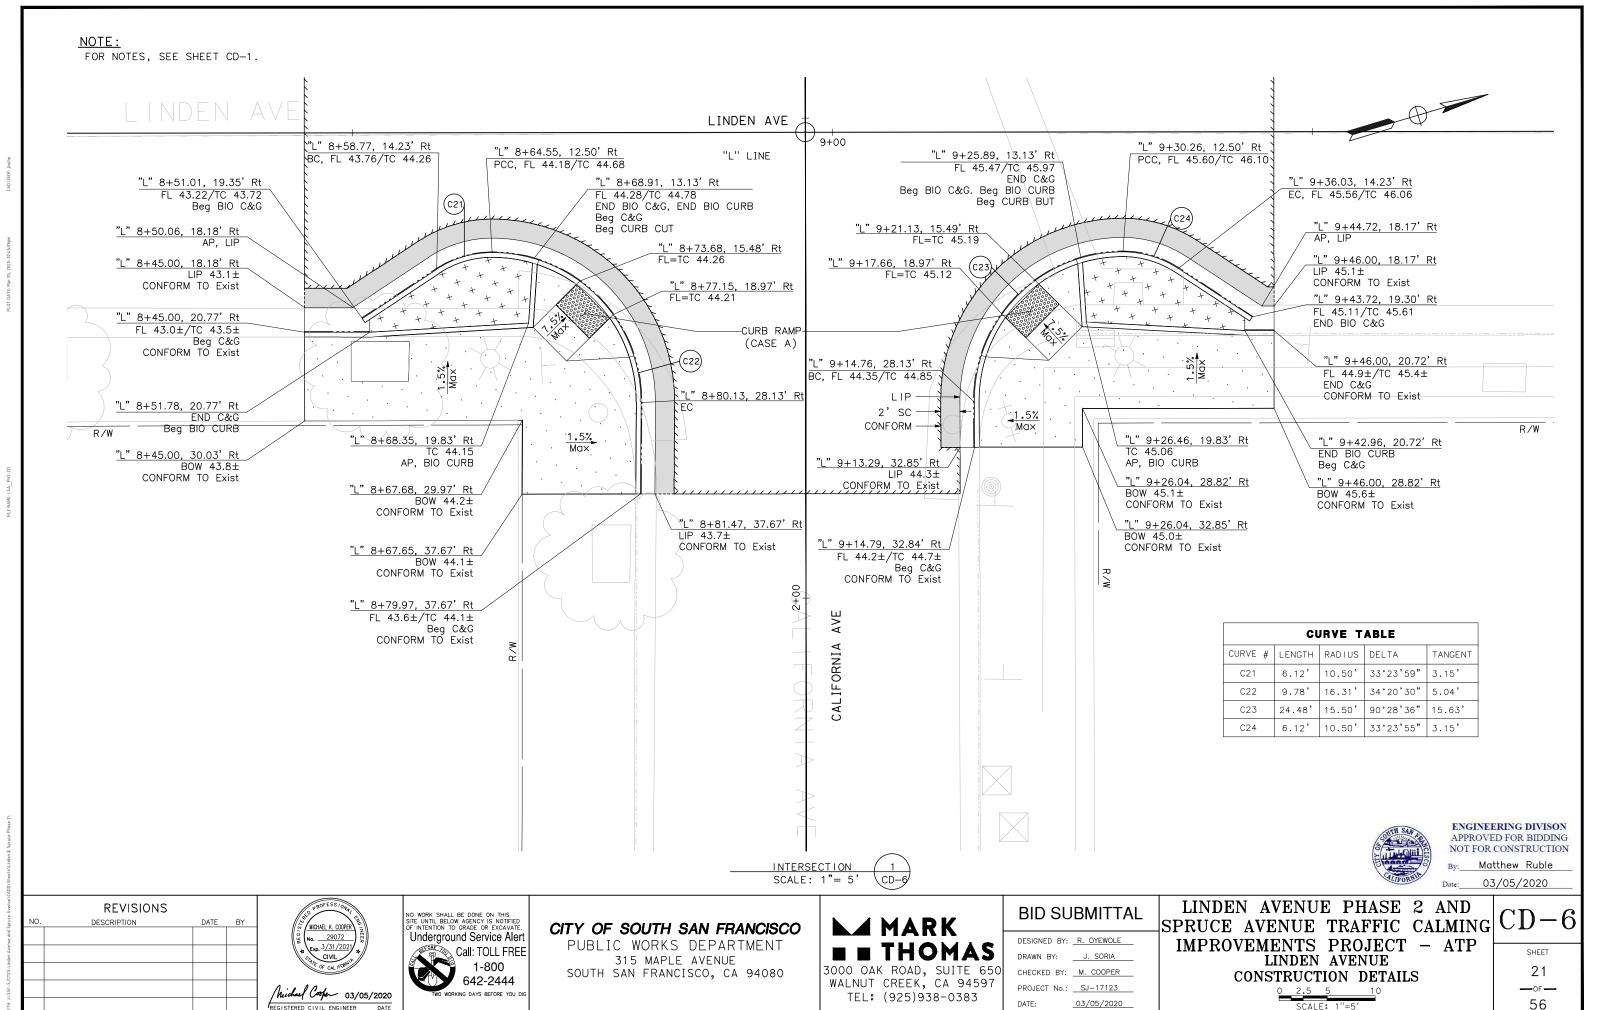

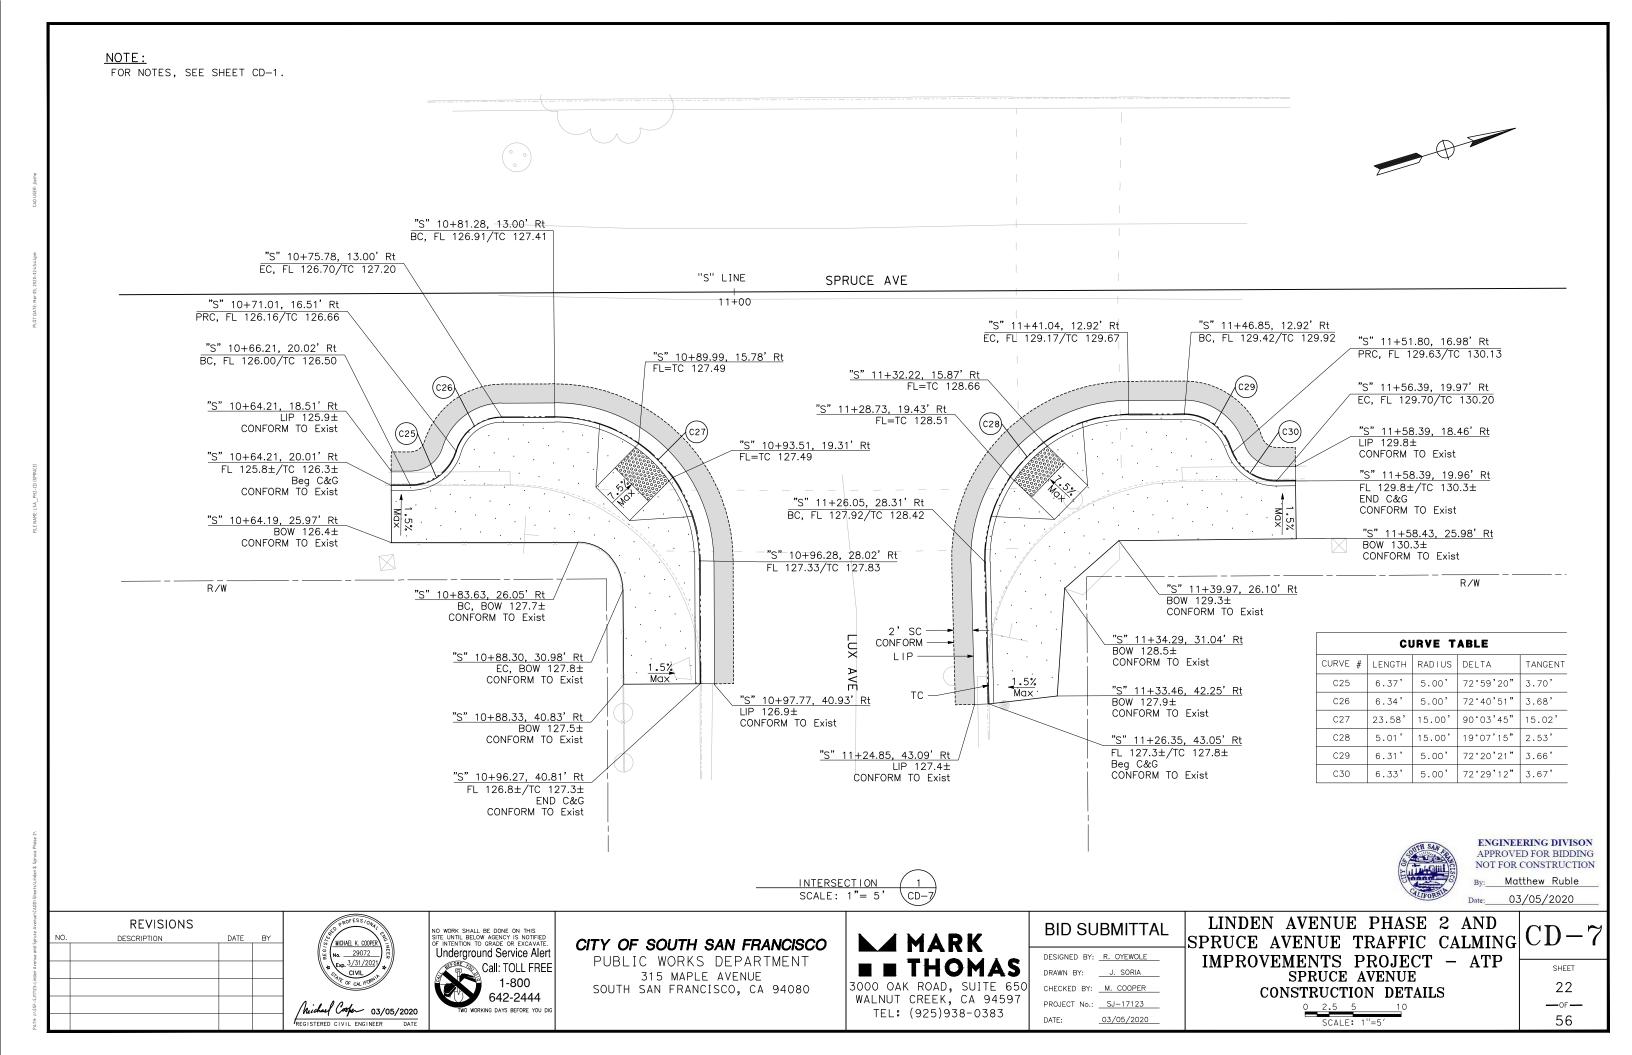

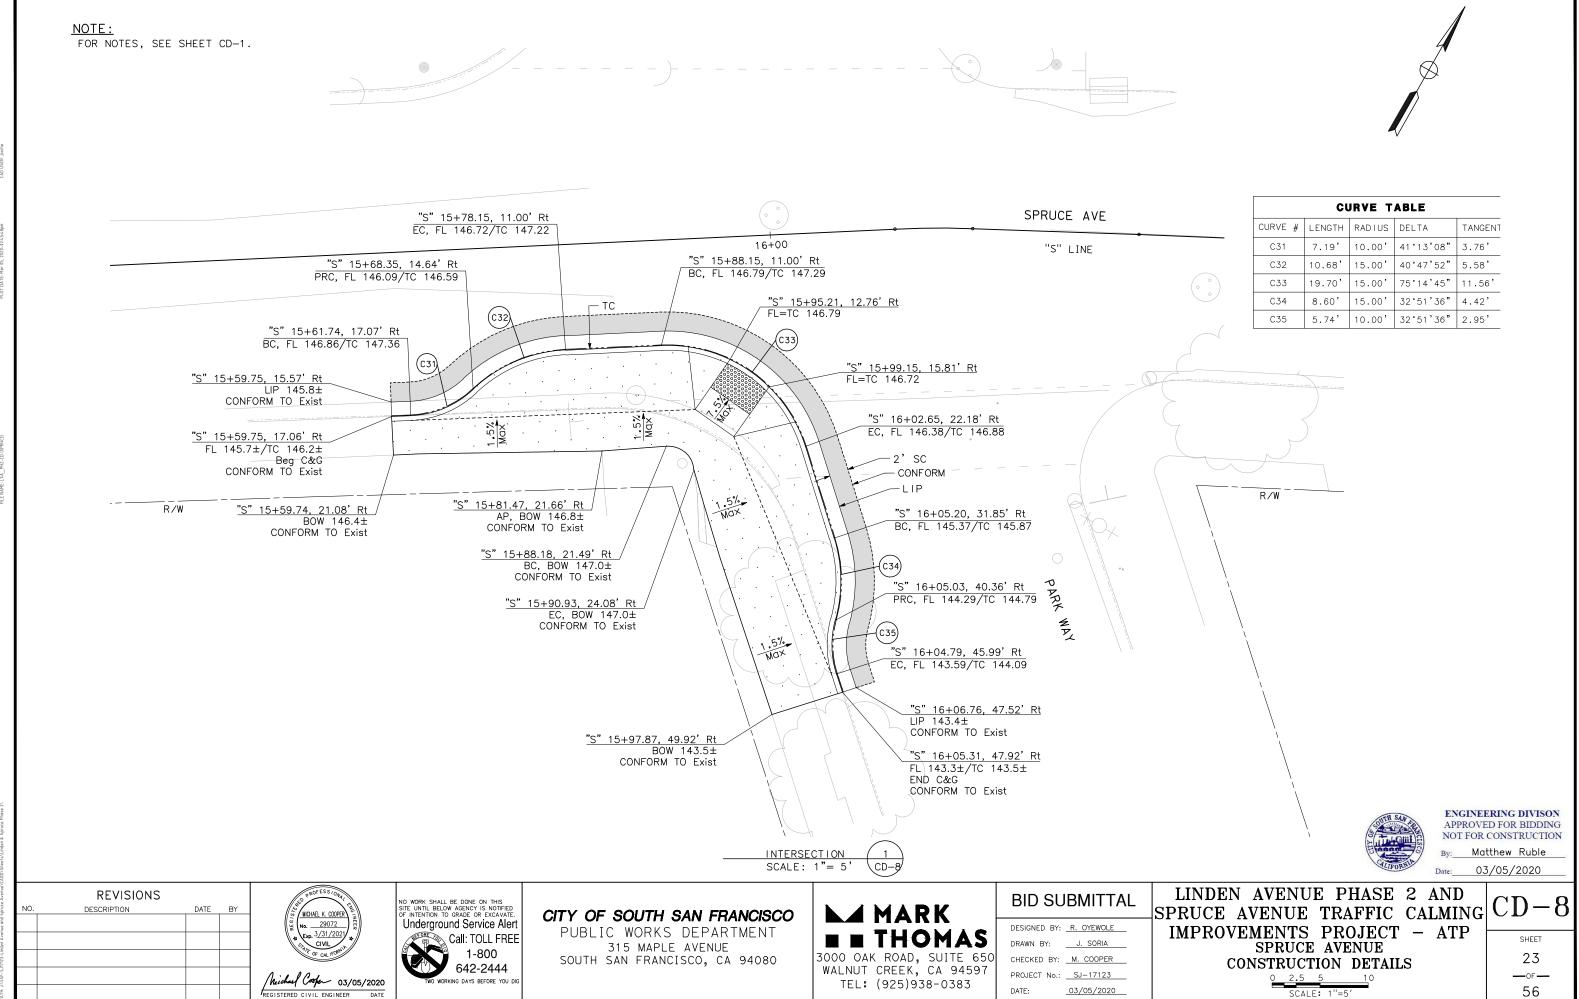


TEL: (925)938-0383

03/05/2020


56

REGISTERED CIVIL ENGINEER DATE

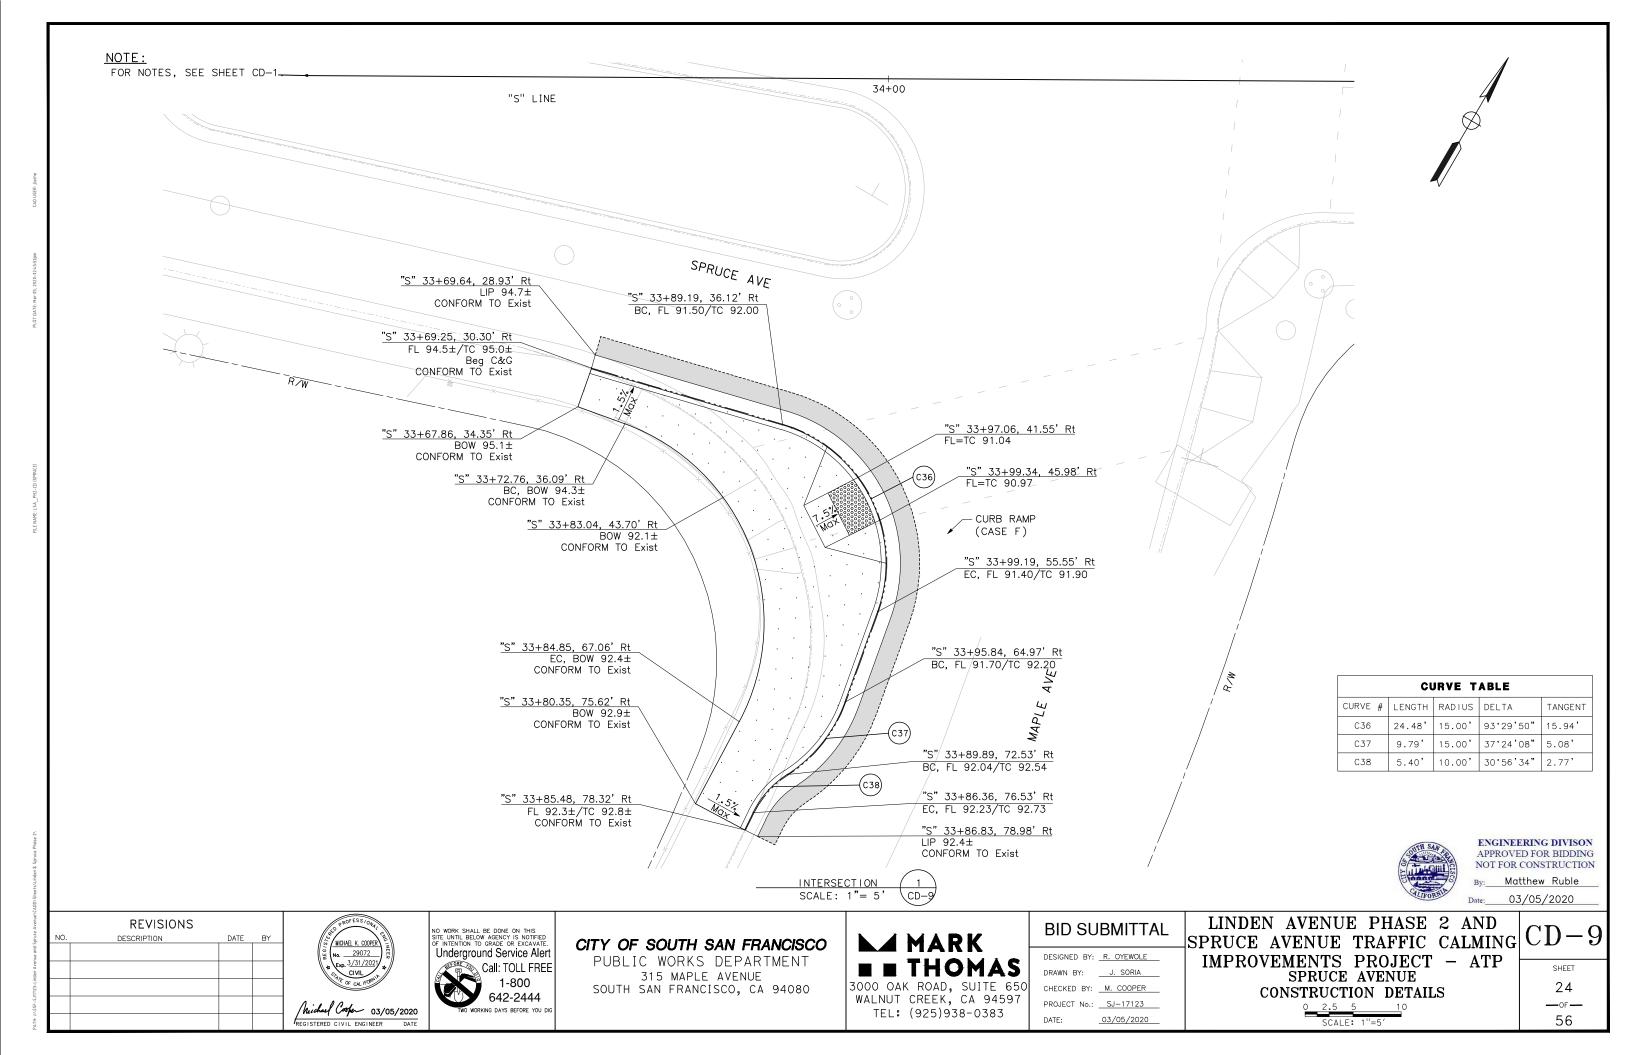

FOR NOTES, SEE SHEET CD-1.



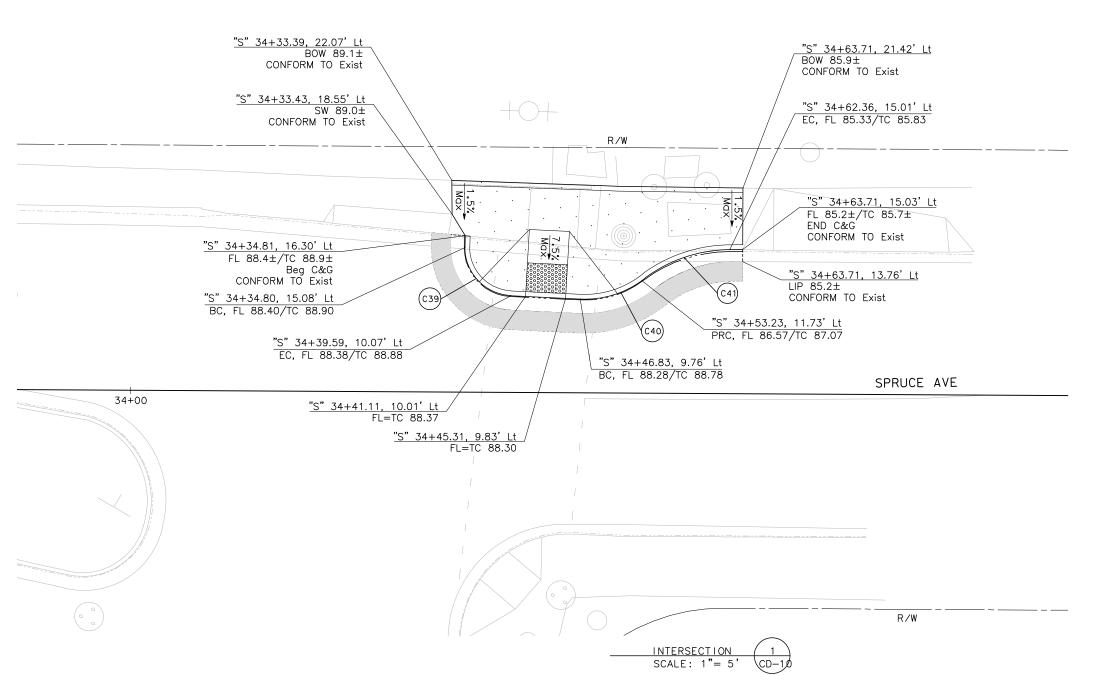

CURVE TABLE				
CURVE #	LENGTH	RADIUS	DELTA	TANGENT
C39	7.65	5.00'	87°38'12"	4.80'
C40	6.83'	10.00'	39°07'41"	3.55'
C41	9.35'	15.00'	35°43'48"	4.83'



ENGINEERING DIVISON APPROVED FOR BIDDING NOT FOR CONSTRUCTION By: Matthew Ruble Date: 03/05/2020

REVISIONS				
NO.	DESCRIPTION	DATE	BY	



NO WORK SHALL BE DONE ON THIS SITE UNTIL BELOW AGENCY IS NOTIFIED OF INTENTION TO GRADE OR EXCAVATE.

Underground Service Alert Call: TOLL FREE 1-800 642-2444

CITY OF SOUTH SAN FRANCISCO

PUBLIC WORKS DEPARTMENT 315 MAPLE AVENUE SOUTH SAN FRANCISCO, CA 94080

⊿ MARK **THOMA** 3000 OAK ROAD, SUITE

	DESIGNED BY: R. OYEWOLE
■ ■ THOMAS	DRAWN BY: <u>J. SORIA</u>
3000 OAK ROAD, SUITE 650	CHECKED BY: M. COOPER
WALNUT CREEK, CA 94597	PROJECT No.: SJ-17123
TEL: (925)938-0383	DATE: <u>03/05/2020</u>


BID SUBMITTAL

LINDEN AVENUE PHASE 2 AND SPRUCE AVENUE TRAFFIC CALMING CD-10 IMPROVEMENTS PROJECT - ATP SPRUCE AVENUE

CONSTRUCTION DETAILS 0 2.5 5 SCALE: 1"=5'


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FOR NOTES AND LEGEND, SEE SHEET D-1.



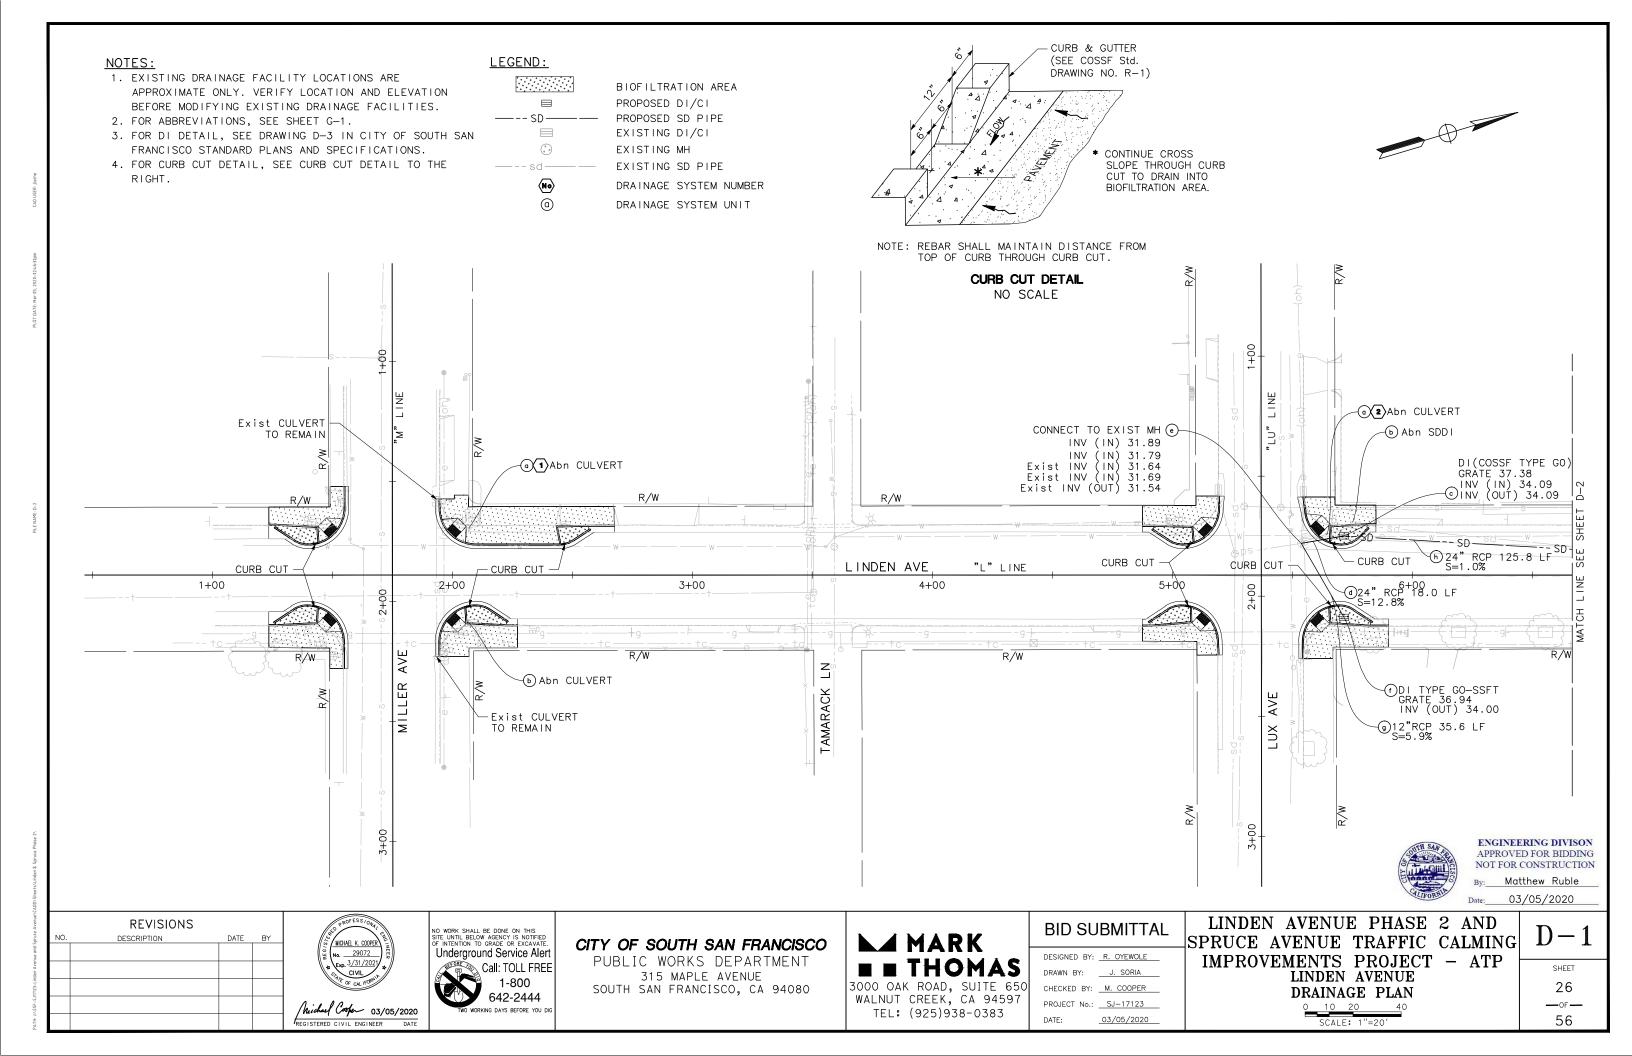



REVISIONS				
NO.	DESCRIPTION	DATE	BY	

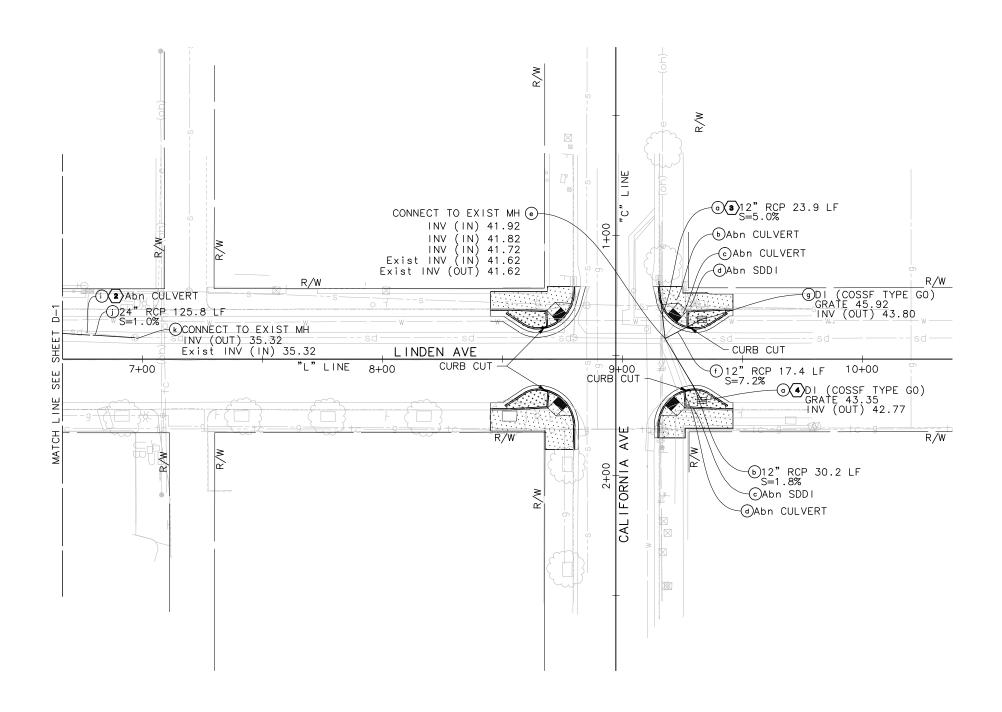MICHAEL K. COOPER TO STAND TO

NO WORK SHALL BE DONE ON THIS SITE UNTIL BELOW AGENCY IS NOTIFIED OF INTENTION TO GRADE OR EXCAVATE.

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TWO WORKING DAYS BEFORE YOU DIG

CITY OF SOUTH SAN FRANCISCO

PUBLIC WORKS DEPARTMENT 315 MAPLE AVENUE SOUTH SAN FRANCISCO, CA 94080

MARK THOMAS 3000 OAK ROAD, SUITE 650

E E INUMAS	DRAV
3000 OAK ROAD, SUITE 650	CHE
WALNUT CREEK, CA 94597	PRO.
TEL: (925)938-0383	DATE

BID	SUBMITT	ΑL
	O O D	

DESIGNED BY:	R. OYEWOLE
DRAWN BY:	J. SORIA
CHECKED BY:	M. COOPER
PROJECT No.:	SJ-17123
DATE:	03/05/2020


LINDEN AVENUE PHASE 2 AND SPRUCE AVENUE TRAFFIC CALMING IMPROVEMENTS PROJECT - ATP LINDEN AVENUE

LINDEN AVENUE DRAINAGE PLAN	_	ATP	
<u>0 10 20 4</u> 0			
SCALE: 1"=20'			

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27 — of — 56 NOTES:

- 2. EXISTING UTILITIES AND DRAINAGE SHOWN ARE APPROXIMATE ONLY. IT SHALL BE THE RESPONSIBILITY OF THE CONTRACTOR TO VERIFY THE LOCATION OF ALL EXISTING UTILITIES AT LEAST 48 HOURS BEFORE EXCAVATION BEGINS. CALL UNDERGROUND SERVICE ALERT AT 811.
- 3. UTILITIES SHALL BE KEPT IN SERVICE AT ALL TIMES.
- 4. EXISTING ELECTRIC, GAS, PETROLEUM, SEWER FORCE MAIN AND OTHER UTILITIES IN THE VICINITY OF CONSTRUCTION SHALL REMAIN AND BE PROTECTED IN PLACE AS SHOWN ON THIS SHEET.
- 5. FOR PROPOSED DRAINAGE FACILITIES, SEE DRAINAGE PLANS.
- 6. GENERAL CONTRACTOR TO RESTORE TRAFFIC SIGNAL LOOPS IN KIND AND PER CITY STANDARDS.

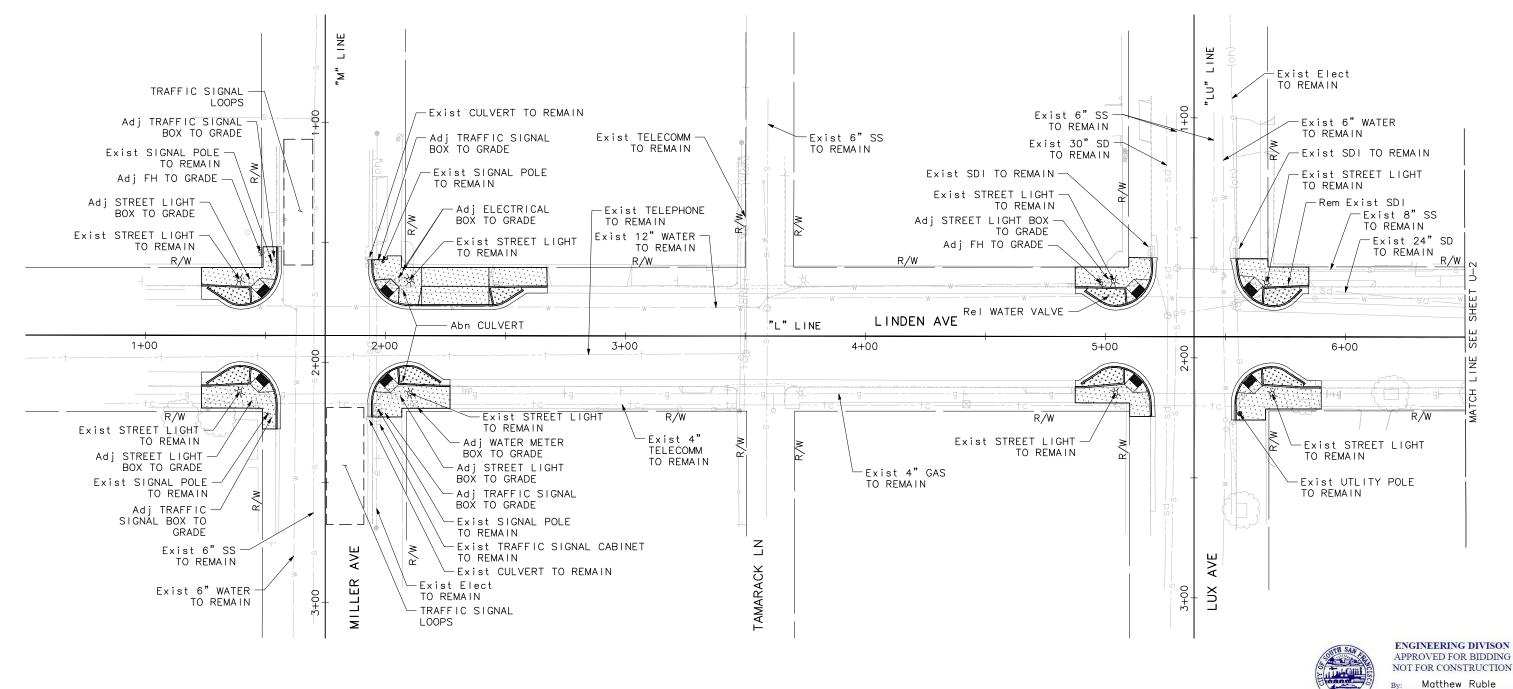

PATH: INSSF-SJITI23-Linden Avenue and Spruce Avenue\CADD\Sheets\Linden & Spruce I.

REVISIONS

10. DESCRIPTION DATE BY

MICHAEL K. COOPER ST. ONAL PORTS OF CALL POR

REGISTERED CIVIL ENGINEER DATE

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SITE UNTIL BELOW AGENCY IS NOTIFIED
OF INTENTION TO GRADE OR EXCAVATE.
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Call: TOLL FREE
1-800
642-2444
TWO WORKING DAYS BEFORE YOU DIG

CITY OF SOUTH SAN FRANCISCO

PUBLIC WORKS DEPARTMENT 315 MAPLE AVENUE SOUTH SAN FRANCISCO, CA 94080

MARK THOMAS 3000 OAK ROAD, SUITE 650 WALNUT CREEK, CA 94597

TEL: (925)938-0383

ESIGNED BY:	R. OYEWOLE	
RAWN BY:	J. SORIA	
HECKED BY:	M. COOPER	
ROJECT No.:	SJ-17123	

03/05/2020

BID SUBMITTAL


LINDEN AVENUE PHASE 2 AND SPRUCE AVENUE TRAFFIC CALMING IMPROVEMENTS PROJECT — ATP LINDEN AVENUE UTILITY PLAN

O 10 20 40 40 SCALE: 1"=20'

U — I

03/05/2020

28 — of — 56

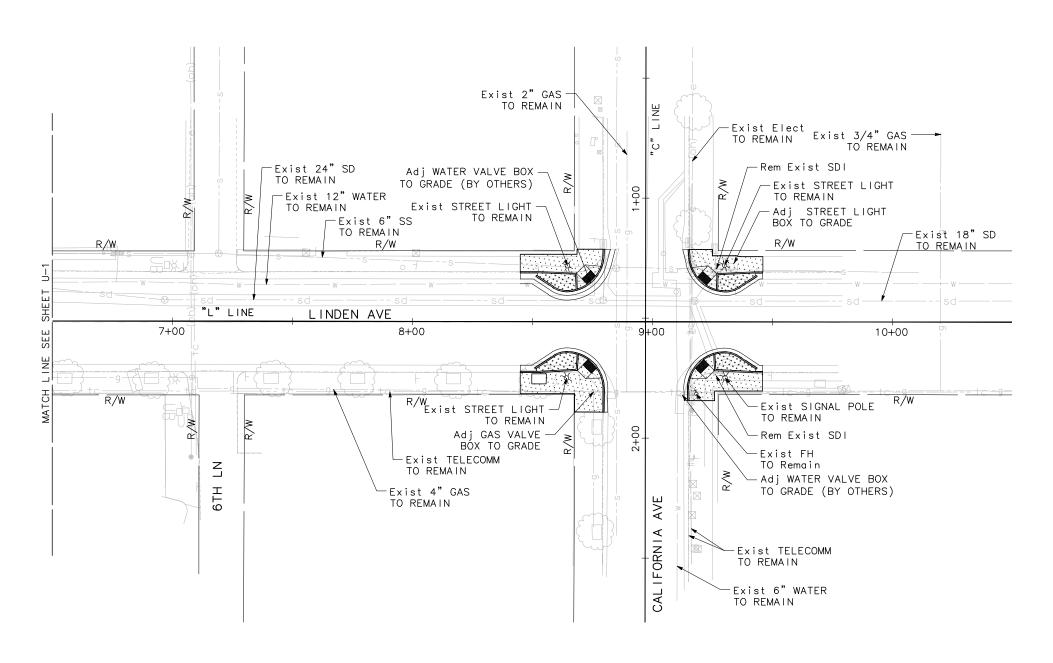



ENGINEERING DIVISON
APPROVED FOR BIDDING
NOT FOR CONSTRUCTION
By: Matthew Ruble
Date: 03/05/2020

	REVISIONS				
NO.	NO. DESCRIPTION DATE				





CITY OF SOUTH SAN FRANCISCO

PUBLIC WORKS DEPARTMENT
315 MAPLE AVENUE
SOUTH SAN FRANCISCO, CA 94080

MARK THOMAS 3000 OAK ROAD, SUITE 650 WALNUT CREEK, CA 94597


TEL: (925)938-0383

BID SUBMITTAL


DESIGNED BY:	R. OYEWOLE
DRAWN BY:	J. SORIA
CHECKED BY:	M. COOPER
PROJECT No.:	SJ-17123
DATE:	03/05/2020

LINDEN AVENUE PHASE 2 AND SPRUCE AVENUE TRAFFIC CALMING IMPROVEMENTS PROJECT - ATP LINDEN AVENUE UTILITY PLAN

ENTS PROJECT - ATP [INDEN AVENUE	SHEET
UTILITY PLAN	29
0 10 20 40	— OF —
SCALE: 1"=20'	56

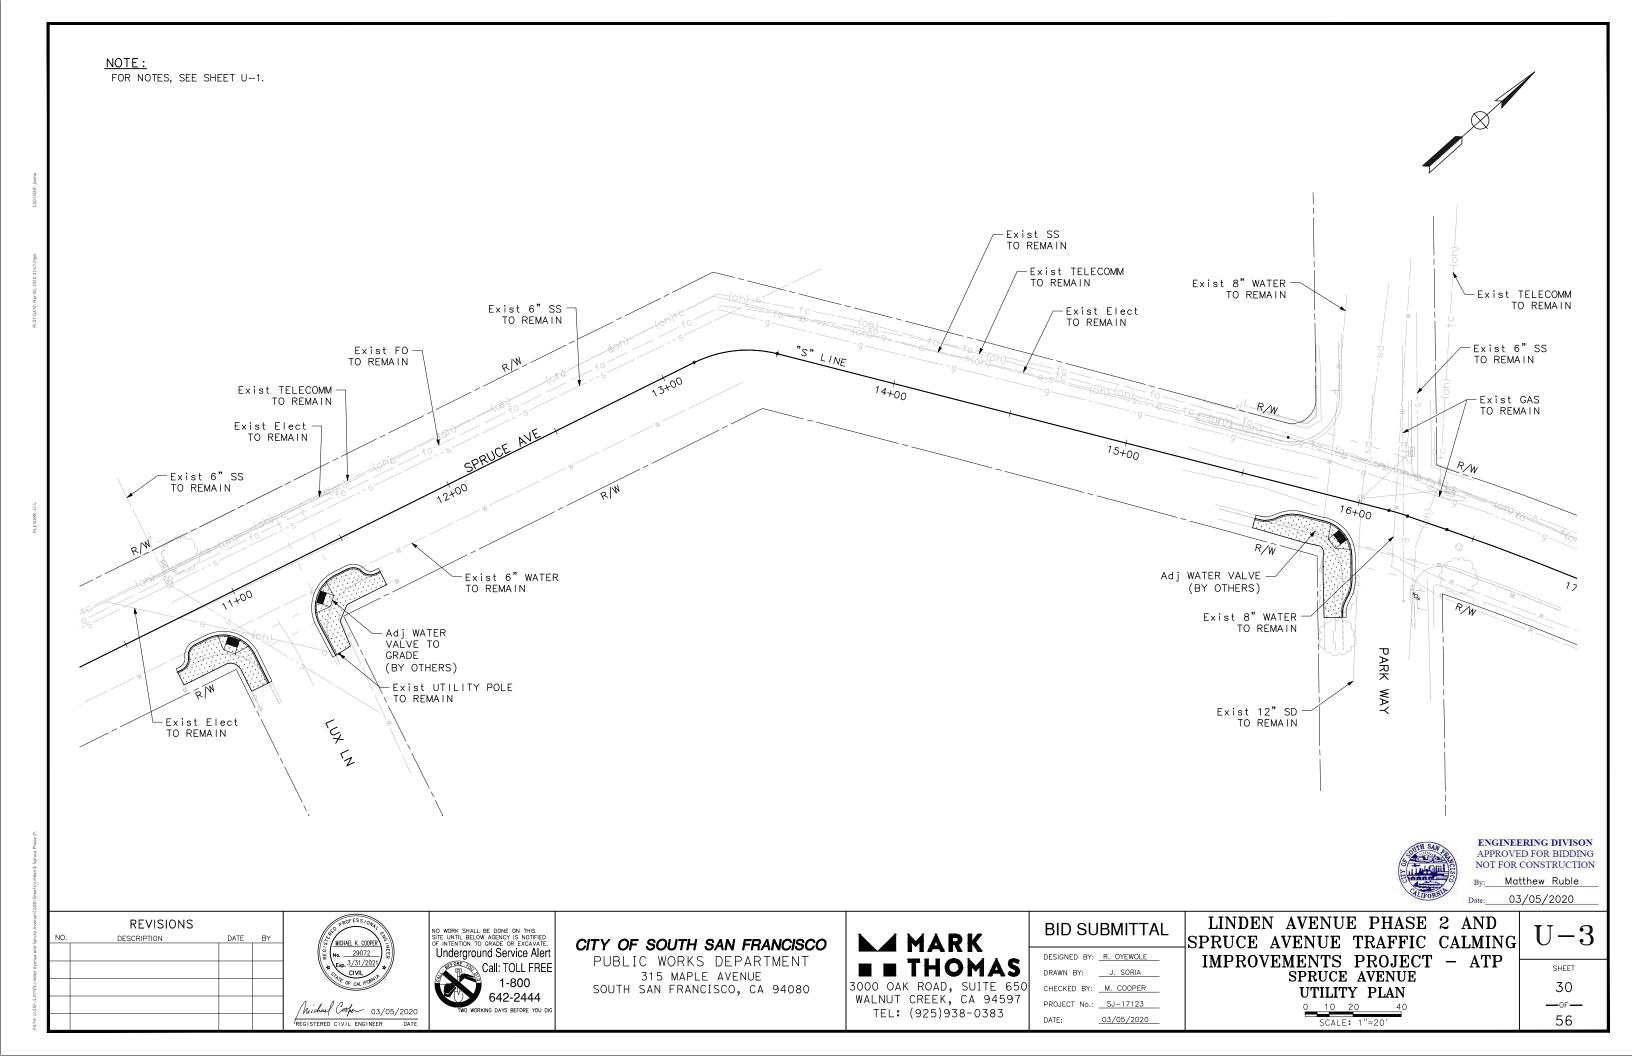

FOR NOTES, SEE SHEET U-1.

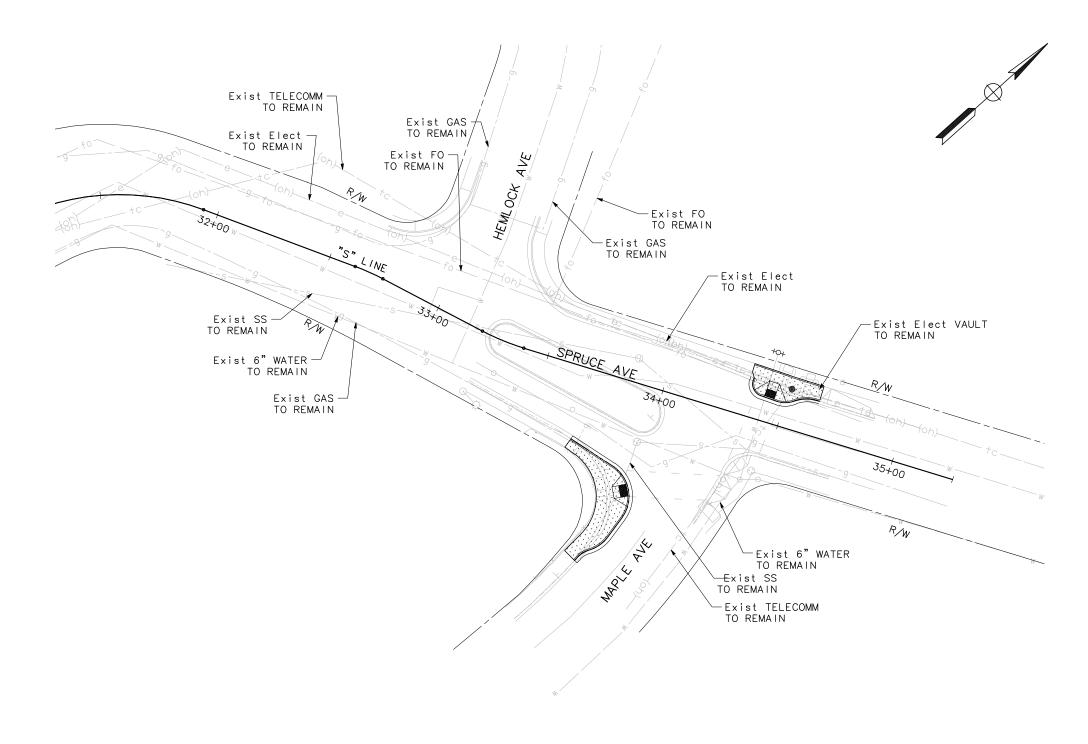

SATI SAN

ENGINEERING DIVISON
APPROVED FOR BIDDING
NOT FOR CONSTRUCTION
By: Matthew Ruble

Date: 03/05/2020

	REVISIONS			
NO. DESCRIPTION DATE				



NO WORK SHALL BE DONE ON THIS SITE UNTIL BELOW ACENCY IS NOTIFIED OF INTENTION TO GRADE OR EXCAVATE.

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1-800
642-2444

TWO WORKING DAYS BEFORE YOU DIG

CITY OF SOUTH SAN FRANCISCO PUBLIC WORKS DEPARTMENT

PUBLIC WORKS DEPARTMENT
315 MAPLE AVENUE
SOUTH SAN FRANCISCO, CA 94080

MARK THOMAS 3000 OAK ROAD, SUITE 650

WALNUT CREEK, CA 94597

TEL: (925)938-0383

BID SUBMITTAL			
DESIGNED BY:	R. OYEWOLE		
DRAWN BY:	J. SORIA		
CHECKED BY:	M. COOPER		
PROJECT No.:	SJ-17123		

03/05/2020

LINDEN AVENUE PHASE 2 AND
SPRUCE AVENUE TRAFFIC CALMING
IMPROVEMENTS PROJECT - ATP
SPRUCE AVENUE
UTILITY PLAN

0 10 20 40 SCALE: 1"=20'

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	SHEET
	31
	—OF —
	56

CROSSWALK LADDER DETAIL NO SCALE

> Matthew Ruble 03/05/2020

> > SHEET

32

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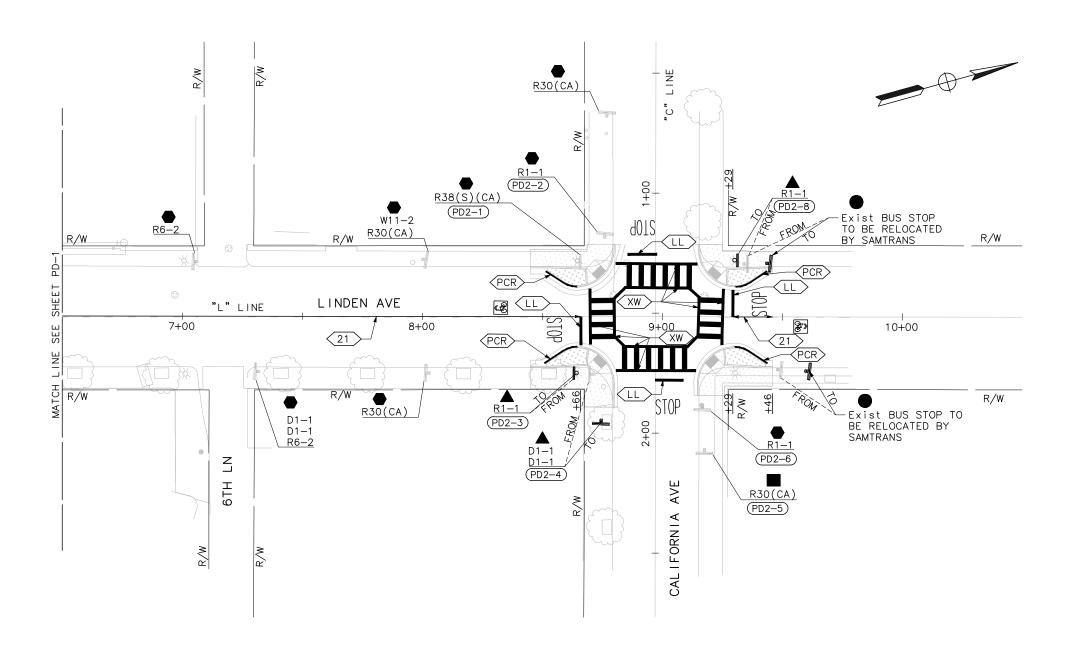
56

D1-1 R30(CA) (PD1-14) PED 6+00 **}*** R/W R30(CA) R1-1 (PD1-15) "SOUTH CITY" (PD1-16) ENGINEERING DIVISON APPROVED FOR BIDDING NOT FOR CONSTRUCTION

03/05/2020

REGISTERED CIVIL ENGINEER DATE

FOR NOTES, SEE SHEET PD-1.





ENGINEERING DIVISON APPROVED FOR BIDDING NOT FOR CONSTRUCTION By: Matthew Ruble Date: 03/05/2020

REVISIONS			
NO. DESCRIPTION DATE B			

MICHAEL K. COOPER
No. 29072
Exp. 3/31/2021 Michael Cooper 03/05/2020
REGISTERED CIVIL ENGINEER DATE

NO WORK SHALL BE DONE ON THIS SITE UNTIL BELOW AGENCY IS NOTIFIED OF INTENTION TO GRADE OR EXCAVATE.

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1-800
642-2444

CITY OF SOUTH SAN FRANCISCO

PUBLIC WORKS DEPARTMENT 315 MAPLE AVENUE SOUTH SAN FRANCISCO, CA 94080

► MARK 3000 WAL


	DESIGNED BY: S. LEE
■ THOMAS	DRAWN BY: N. ENG
O OAK ROAD, SUITE 650	CHECKED BY: M. COOPER
LNUT CREEK, CA 94597	PROJECT No.: SJ-17123
TEL: (925)938-0383	DATE: <u>03/05/2020</u>

BID SUBMITTAL	LINDEN AVENUE PHASE 2 AND SPRUCE AVENUE TRAFFIC CALMING
DESIGNED BY:S. LEE	IMPROVEMENTS PROJECT - ATP
DRAWN BY: N. ENG	LINDEN AVENUE
CHECKED BY: M. COOPER	PAVEMENT DELINEATION & SIGNING PLAN


0 10 20 SCALE: 1"=20'

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56

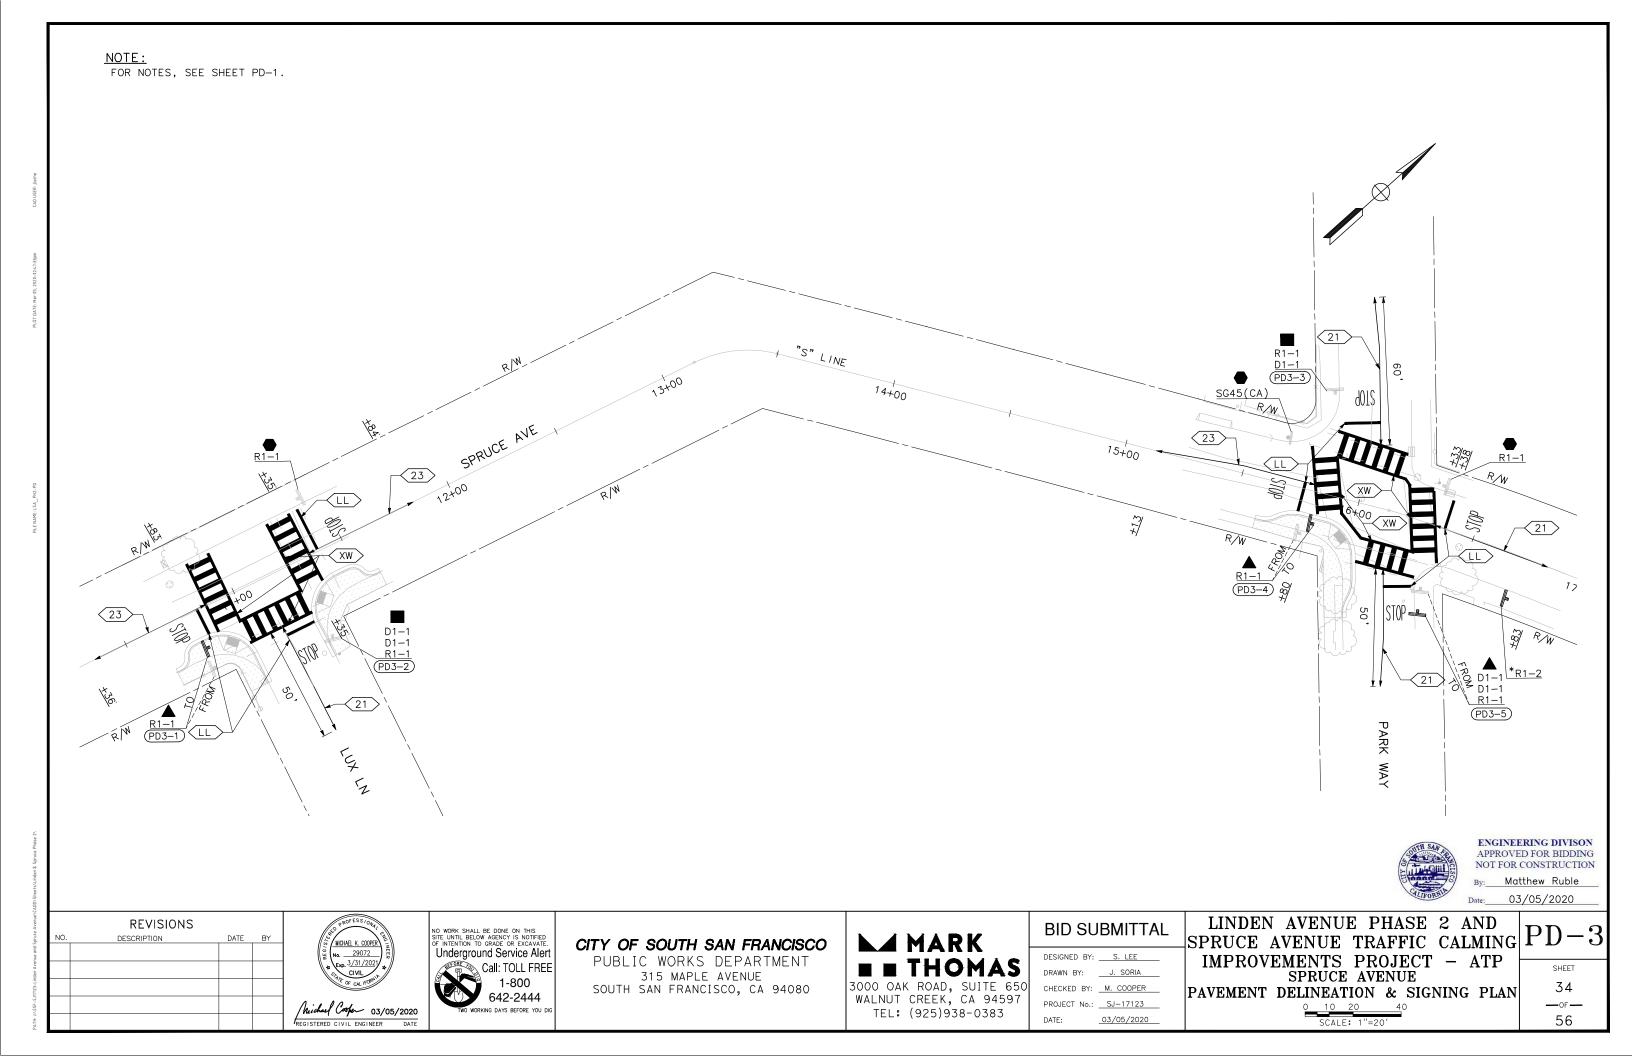

FOR NOTES, SEE SHEET PD-1.



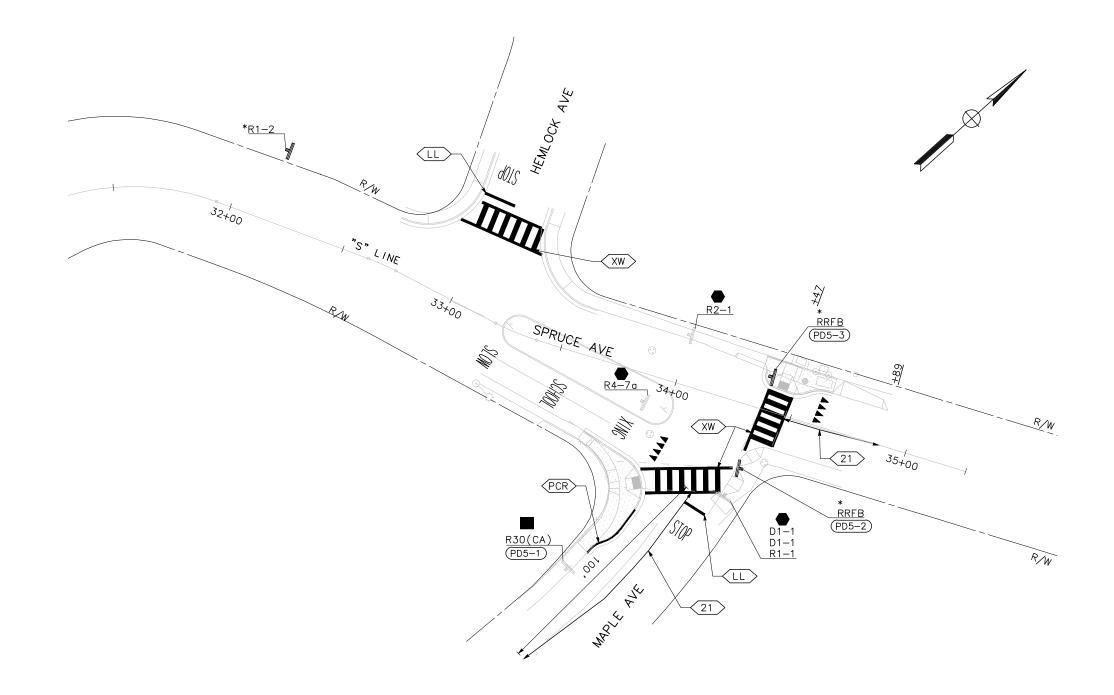

ENGINEERING DIVISON APPROVED FOR BIDDING NOT FOR CONSTRUCTION By: Matthew Ruble Date: 03/05/2020

	REVISIONS		
NO.	DESCRIPTION	DATE	BY



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Underground Service Alert Call: TOLL FREE 1-800 642-2444

CITY OF SOUTH SAN FRANCISCO PUBLIC WORKS DEPARTMENT

315 MAPLE AVENUE SOUTH SAN FRANCISCO, CA 94080

► MARK THOMAS 3000 OAK ROAD, SUITE 650 WALNUT CREEK, CA 94597

TEL: (925)938-0383

BID SU	BMITTAL
DESIGNED BY:	S. LEE
DRAWN BY:	J. SORIA
CHECKED BY:	M. COOPER
PROJECT No.:	SJ-17123

03/05/2020

LINDEN	N AVENU	E PHASE	2 AND	
SPRUCE	AVENUE	TRAFFIC	CALMIN	3
IMPROV			T – ATP	
	SPRUCE	AVENUE		
PAVEMENT	DELINEAT	'ION & SI	GNING PLAI	N
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	SCALE	: 1"=20'		

Ţ	PD-4
	SHEET

35 ---OF---56

- 1. ALL UTILITIES WILL BE CONSTRUCTED OR RELOCATED PRIOR TO COMMENCING WORK IN AREAS IMPACTED BY THE STAGE CONSTRUCTION
- 2. PROPOSED UTILITIES MUST BE CONSTRUCTED AN IN SERVICE PRIOR TO REMOVAL AND ABANDONMENT OF EXISTING UTILITIES.
- 3. FOR PERMANENT STRIPING DETAILS. SEE PAVEMENT DELINEATION AND SIGNING PLANS.
- 4. CONSTRUCTION OF BULBOUTS SHALL NOT BE DONE CONCURRENTLY IN ORDER TO MAINTAIN PEDESTRIAN ACCESS ALONG LINDEN AVENUE AT ALL TIMES.
- 5. CONTRACTOR SHALL COORDINATE WITH SAMTRANS TO MAINTAIN EXISTING BUS STOP AT SAME VICINITY.
- 6. CONTRACTOR SHALL MAINTAIN VEHICULAR AND PEDESTRIAN ACCESS TO ADJACENT PROPERTIES DURING ALL CONSTRUCTION STAGES. CONTRACTOR SHALL COORDINATE WITH LOCAL BUSINESSES TO MAINTAIN DRIVEWAY ACCESS, FOR DRIVEWAY ACCESS DETAIL, SEE


- 7. CONTRACTOR SHALL MAINTAIN PEDESTRIAN ACCESS TO BUS STOP ALONG LINDEN AVENUE AT ALL TIMES.
- 8. CONTRACTOR SHALL COMPLY WITH CALTRANS TEMPORARY PEDESTRIAN FACILITIES HANDBOOK, ISSUED ON JUNE 2014.
- 9. CONSTRUCTION SHALL PROVIDE POSITIVE DRAINAGE AT ALL TIMES.
- 10.FOR PEDESTRIAN ACCESS AND TRAFFIC CONTROL DETAILS NOT SHOWN. SEE 2015 CALTRANS STANDARD PLANS T-11 TO T-13, T-30 TO T-34, AND THE SPECIAL PROVISIONS.
- 11.STAGE CONSTRUCTION PLANS DO NOT SHOW ALL WORK REQUIRED TO BE COMPLETED. WORK NOT NECESSARY FOR TRAFFIC HANDLING MAY BE COMPLETED AT ANY TIME AND IS NOT SHOWN.
- 12. REMOVE CONFLICTING STRIPING & SIGNS PRIOR TO OPENING ROADWAY TO TRAFFIC. FOLLOW GUIDELINES OF 2014 CA MUTCD.
- 13. CONTRACTOR SHALL PREVENT PARKING TO MAINTAIN CLEAR TRAVEL LANES DURING ALL CONSTRUCTIONS STAGES.


LEGEND: CONSTRUCT THIS STAGE TRAFFIC CONE BARRICADE TEMPORARY TRAFFIC CONTROL SIGN ON BARRICADE TEMPORARY TRAFFIC CONTROL SIGN

PORTABLE FLASHING BEACON

(NO.)

TEMPORARY PAVEMENT DELINEATION DETAIL NUMBER

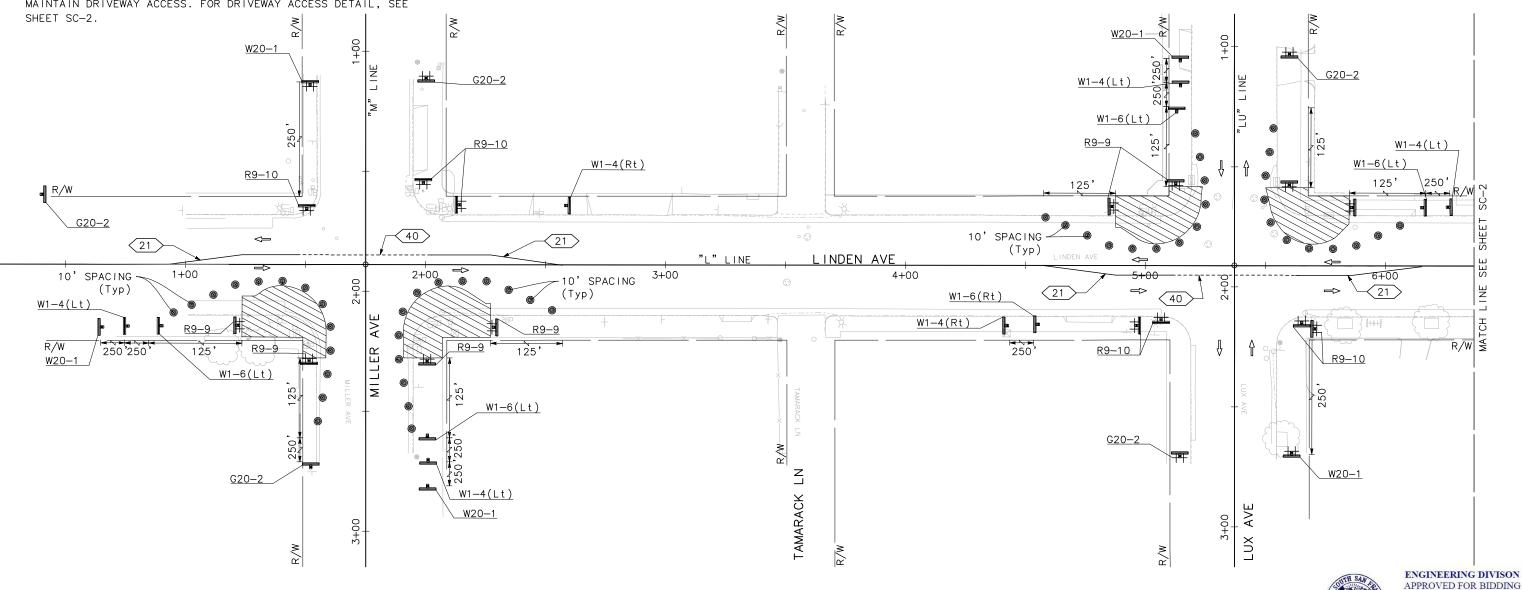

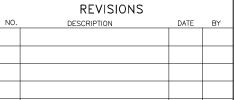



Underground Service Alert Call: TOLL FREE 1-800 642-2444

CITY OF SOUTH SAN FRANCISCO

PUBLIC WORKS DEPARTMENT 315 MAPLE AVENUE SOUTH SAN FRANCISCO, CA 94080

⊿ MARK 3000 OAK ROAD, SUITE 650 WALNUT CREEK, CA 94597

TEL: (925)938-0383

BID SUBMITTAL

DESIGNED BY: R. OYEWOLE DRAWN BY: J. SORIA CHECKED BY: M. COOPER PROJECT No.: SJ-17123 03/05/2020

LINDEN AVENUE PHASE 2 AND SPRUCE AVENUE TRAFFIC CALMING SU-IMPROVEMENTS PROJECT - ATP LINDEN AVENUE

STAGE CONSTRUCTION-TRAFFIC HANDLING PLANS STAGE 1 0 10 20 SCALE: 1"=20'

SHEET

NOT FOR CONSTRUCTION Matthew Ruble 03/05/2020

> 36 —OF — 56



REVISIONS





CITY OF SOUTH SAN FRANCISCO

PUBLIC WORKS DEPARTMENT 315 MAPLE AVENUE SOUTH SAN FRANCISCO, CA 94080

⊿ MARK **THOMAS** 3000 OAK ROAD, SUITE 650 WALNUT CREEK, CA 94597

TEL: (925)938-0383


BID SUBMITTAL
DESIGNED BY: R. OYEWOLE
DRAWN BY:
CHECKED BY: M. COOPER
PROJECT No.: SJ-17123

03/05/2020

LINDEN AVENUE PHASE 2 AND SPRUCE AVENUE TRAFFIC CALMING	SC.
SPRUCE AVENUE TRAFFIC CALMING	
IMPROVEMENTS PROJECT - ATP	
	SHE
LINDEN AVENUE	

0 10 20 SCALE: 1"=20'

IMPROVEMENTO PROJECT AND	
IMPROVEMENTS PROJECT – ATP	SHEET
STAGE CONSTRUCTION-TRAFFIC HANDLING PLANS STAGE 1	37
0 10 20 40	—OF —
SCALE: 1"-20'	56

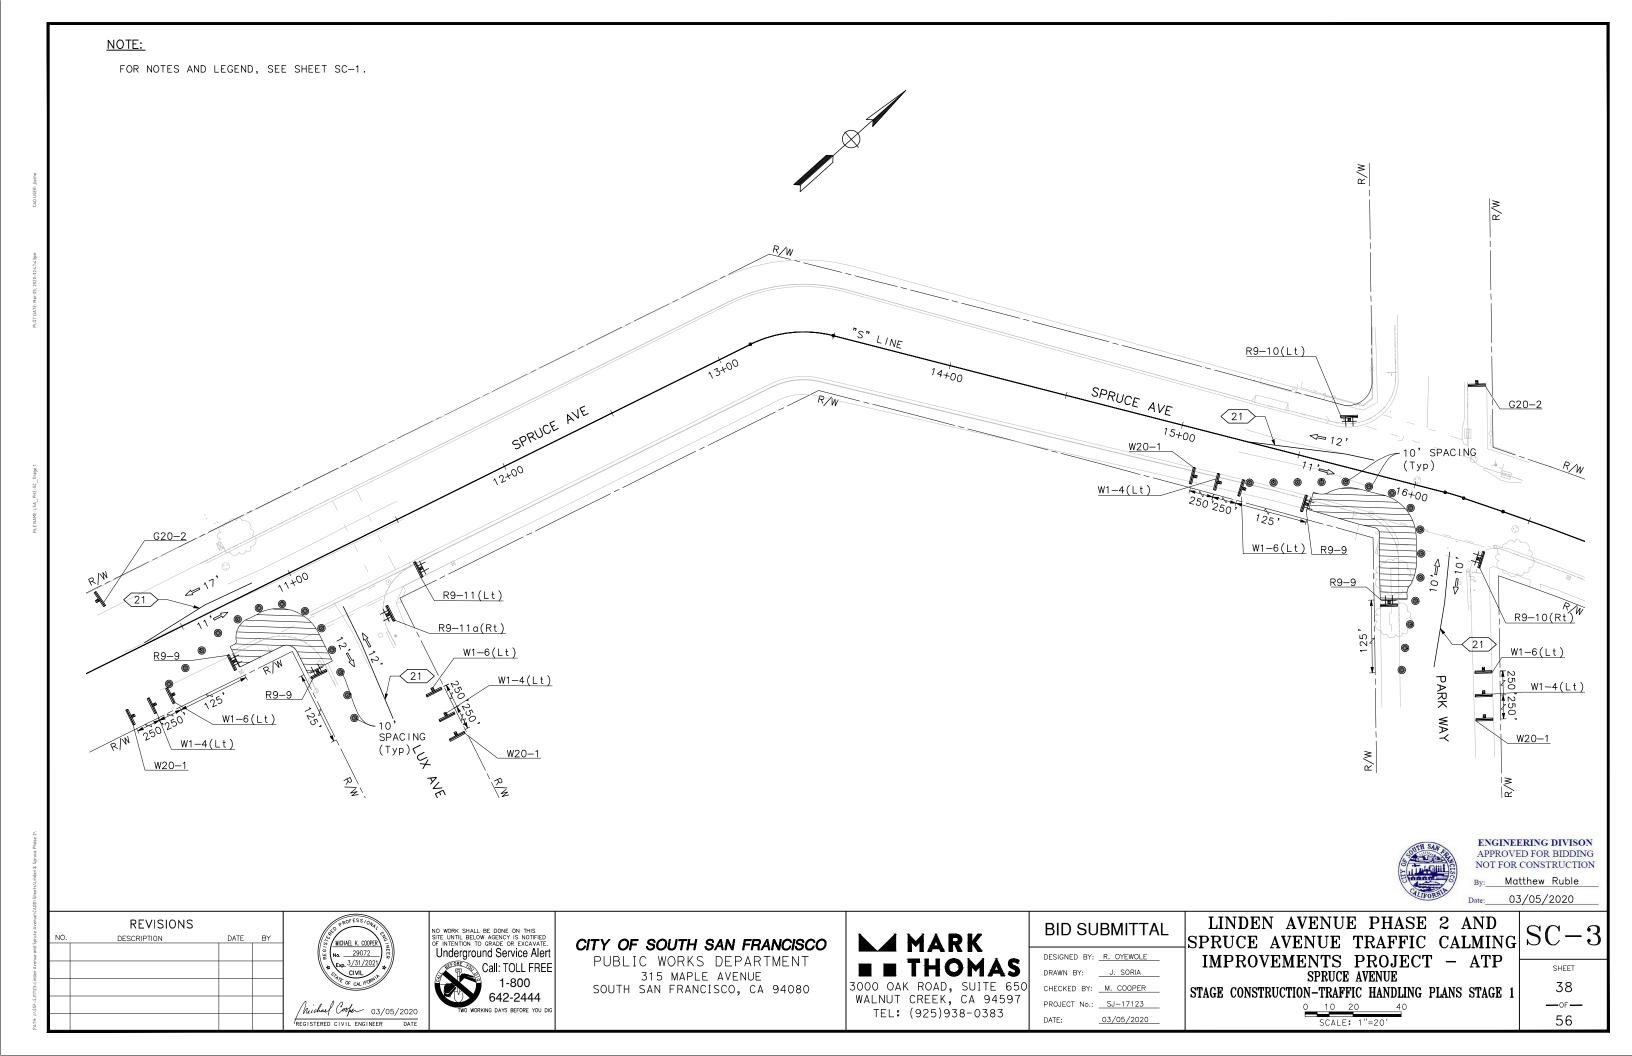

ENGINEERING DIVISON APPROVED FOR BIDDING NOT FOR CONSTRUCTION Matthew Ruble Date: 03/05/2020

REVISIONS			
NO.	DESCRIPTION	DATE	BY





CITY OF SOUTH SAN FRANCISCO PUBLIC WORKS DEPARTMENT

315 MAPLE AVENUE SOUTH SAN FRANCISCO, CA 94080

MARK THOMAS 3000 OAK ROAD, SUITE 650 WALNUT CREEK, CA 94597

TEL: (925)938-0383

DESIGNED BY:	R. OYEWOLE
DRAWN BY:	J. SORIA
CHECKED BY:	M. COOPER
PROJECT No.:	SJ-17123
DATE:	03/05/2020

BID SUBMITTAL

LINDEN AVENUE PHASE 2 AND SPRUCE AVENUE TRAFFIC CALMING SC IMPROVEMENTS PROJECT - ATP SPRUCE AVENUE

IMPROVEMENTS PROJECT - ATP	
SPRUCE AVENUE	SHEET
STAGE CONSTRUCTION-TRAFFIC HANDLING PLANS STAGE 1	39
0 10 20 40	—OF—
SCALE: 1"=20'	56

- 1. ALL UTILITIES WILL BE CONSTRUCTED OR RELOCATED PRIOR TO COMMENCING WORK IN AREAS IMPACTED BY THE STAGE CONSTRUCTION
- 2. PROPOSED UTILITIES MUST BE CONSTRUCTED AN IN SERVICE PRIOR TO REMOVAL AND ABANDONMENT OF EXISTING UTILITIES.
- 3. FOR PERMANENT STRIPING DETAILS, SEE PAVEMENT DELINEATION AND SIGNING PLANS.
- 4. CONSTRUCTION OF BULBOUTS SHALL NOT BE DONE CONCURRENTLY IN ORDER TO MAINTAIN PEDESTRIAN ACCESS ALONG LINDEN AVENUE AT ALL TIMES.
- 5. CONTRACTOR SHALL COORDINATE WITH SAMTRANS TO MAINTAIN EXISTING BUS STOP AT SAME VICINITY.
- 6. CONTRACTOR SHALL MAINTAIN VEHICULAR AND PEDESTRIAN ACCESS TO ADJACENT PROPERTIES DURING ALL CONSTRUCTION STAGES. CONTRACTOR SHALL COORDINATE WITH LOCAL BUSINESSES TO

- 7. CONTRACTOR SHALL MAINTAIN PEDESTRIAN ACCESS TO BUS STOP ALONG LINDEN AVENUE AT ALL TIMES.
- 8. CONTRACTOR SHALL COMPLY WITH CALTRANS TEMPORARY PEDESTRIAN FACILITIES HANDBOOK, ISSUED ON JUNE 2014.
- 9. CONSTRUCTION SHALL PROVIDE POSITIVE DRAINAGE AT ALL TIMES.
- 10.FOR PEDESTRIAN ACCESS AND TRAFFIC CONTROL DETAILS NOT SHOWN. SEE 2015 CALTRANS STANDARD PLANS T-11 TO T-13, T-30 TO T-34, AND THE SPECIAL PROVISIONS.
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- 12. REMOVE CONFLICTING STRIPING & SIGNS PRIOR TO OPENING ROADWAY TO TRAFFIC. FOLLOW GUIDELINES OF 2014 CA MUTCD.
- 13. CONTRACTOR SHALL PREVENT PARKING TO MAINTAIN CLEAR TRAVEL LANES DURING ALL CONSTRUCTIONS STAGES.

CONSTRUCT THIS STAGE

LEGEND:

(NO.)

TRAFFIC CONE


BARRICADE


TEMPORARY TRAFFIC CONTROL SIGN ON BARRICADE

TEMPORARY TRAFFIC CONTROL SIGN

PORTABLE FLASHING BEACON

TEMPORARY PAVEMENT DELINEATION DETAIL NUMBER

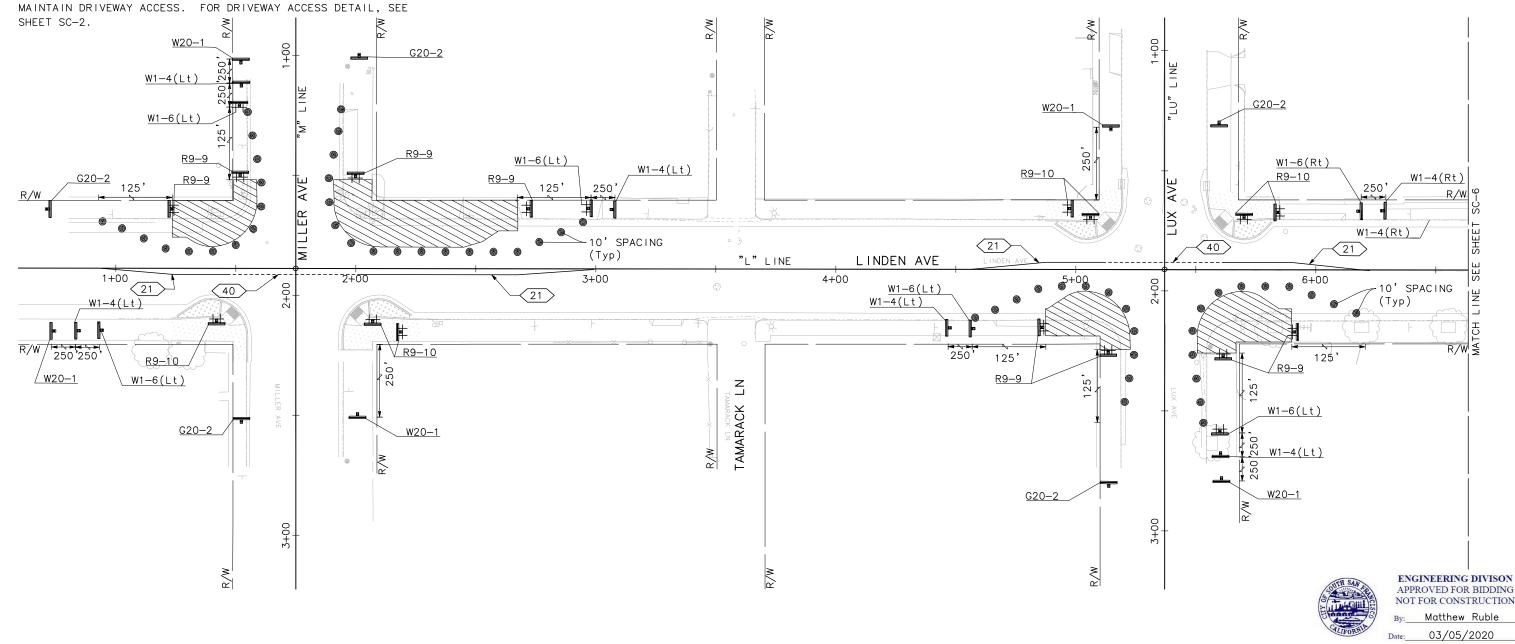

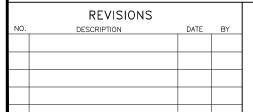



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CITY OF SOUTH SAN FRANCISCO

PUBLIC WORKS DEPARTMENT 315 MAPLE AVENUE SOUTH SAN FRANCISCO, CA 94080

■ MARK 3000 OAK ROAD, SUITE 650 WALNUT CREEK, CA 94597

TEL: (925)938-0383

BID SUBMITTAL

DESIGNED BY:	R. OYEWOLE
DRAWN BY:	J. SORIA
CHECKED BY:	M. COOPER
PROJECT No.:	SJ-17123
DATE:	03/05/2020

LINDEN AVENUE PHASE 2 AND SPRUCE AVENUE TRAFFIC CALMING SC IMPROVEMENTS PROJECT - ATP LINDEN AVENUE

STAGE CONSTRUCTION-TRAFFIC HANDLING PLANS STAGE 2 0 10 20 SCALE: 1"=20'

40 —OF —



ENGINEERING DIVISON APPROVED FOR BIDDING NOT FOR CONSTRUCTION Matthew Ruble 03/05/2020

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NO.	DESCRIPTION	DATE	BY





CITY OF SOUTH SAN FRANCISCO PUBLIC WORKS DEPARTMENT

315 MAPLE AVENUE SOUTH SAN FRANCISCO, CA 94080

⊿ MARK **THOMAS** 3000 OAK ROAD, SUITE 650 WALNUT CREEK, CA 94597

TEL: (925)938-0383


DESIGNED BY:	R. OYEWOLE
DRAWN BY:	J. SORIA
CHECKED BY:	M. COOPER
PROJECT No.:	SJ-17123
DATE:	03/05/2020


BID SUBMITTAL

LINDEN AVENUE PHASE 2 AND SPRUCE AVENUE TRAFFIC CALMING SC IMPROVEMENTS LINDEN

IMPROVEMENTS PROJECT – ATP LINDEN AVENUE	Sł
STAGE CONSTRUCTION-TRAFFIC HANDLING PLANS STAGE 2	4
0 10 20 40 SCALE: 1"=20'	

SHEET
41
OF
56

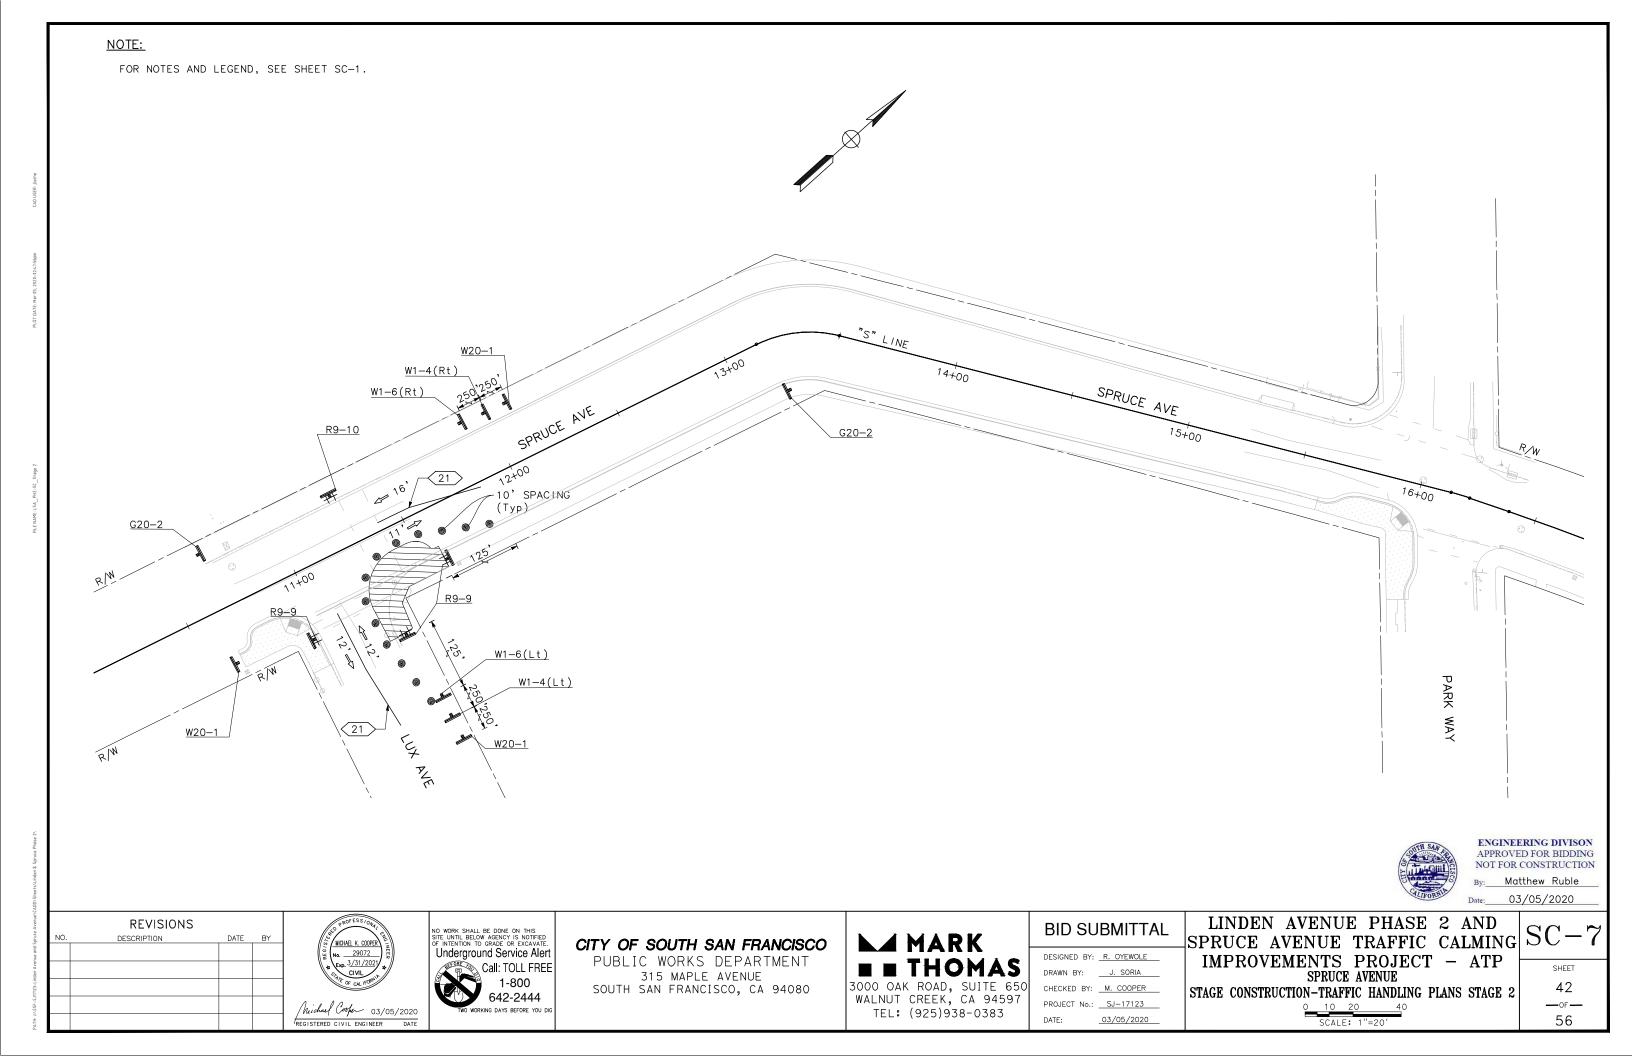

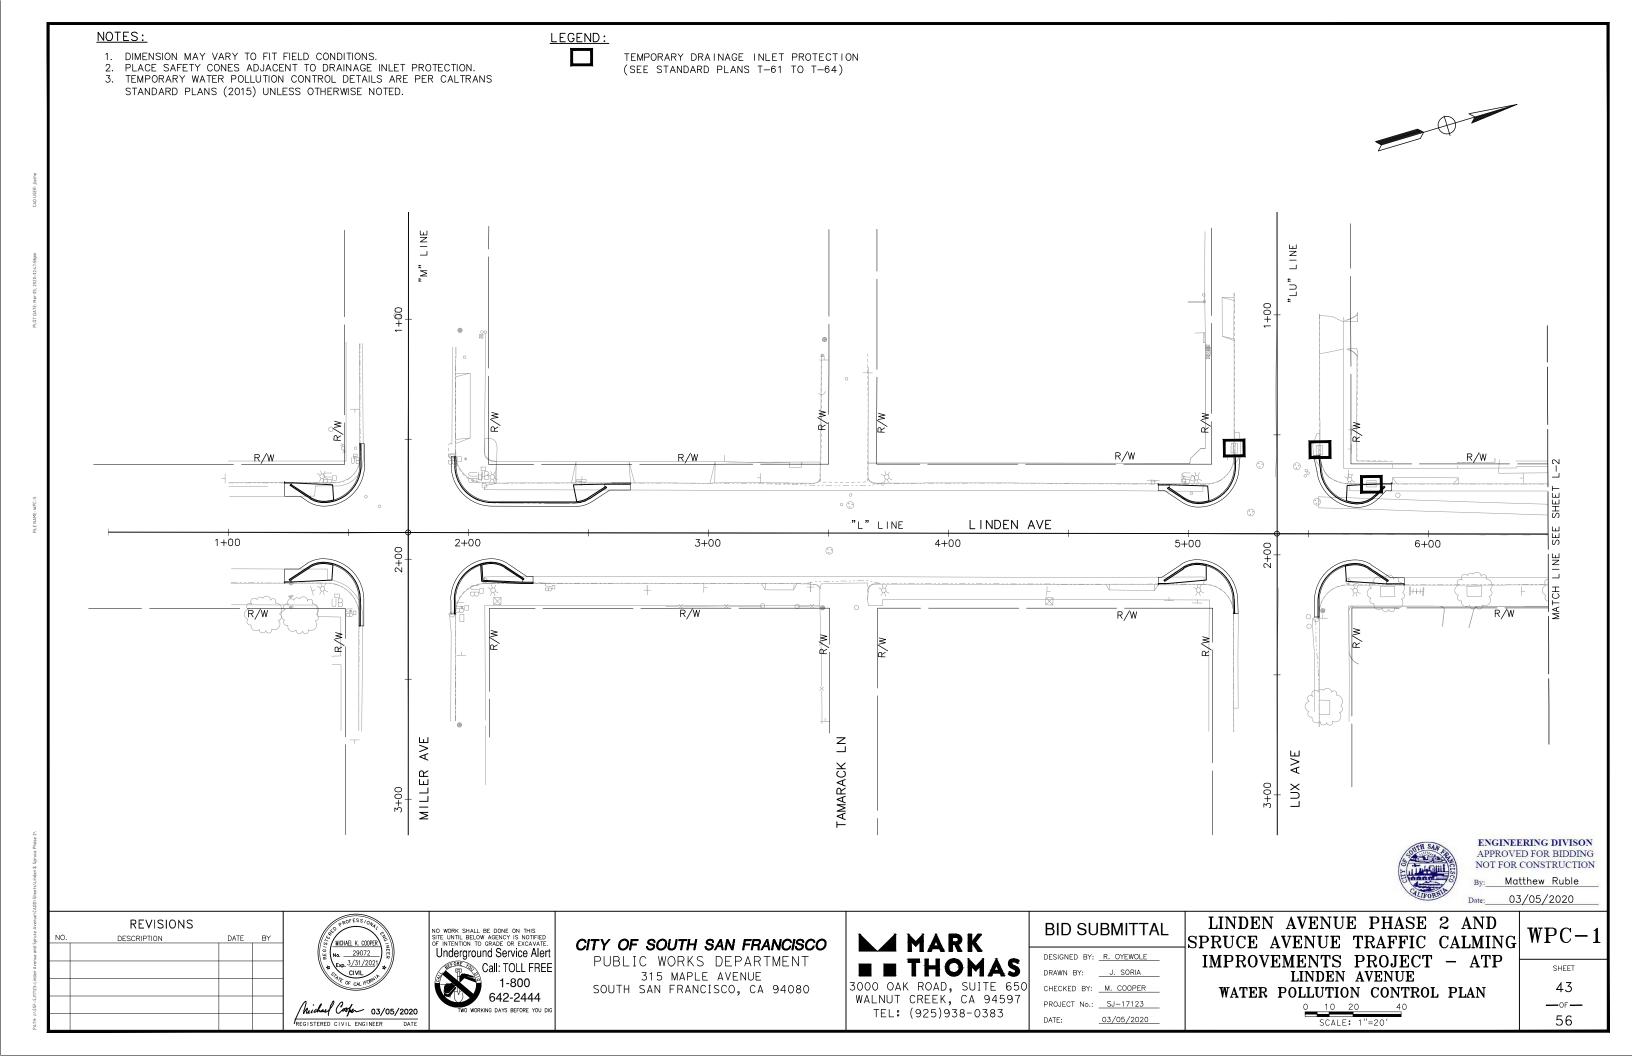



REVISIONS
NO. DESCRIPTION DATE BY





CITY OF SOUTH SAN FRANCISCO

PUBLIC WORKS DEPARTMENT 315 MAPLE AVENUE SOUTH SAN FRANCISCO, CA 94080

MARK THOMAS 3000 OAK ROAD, SUITE 650 WALNUT CREEK, CA 94597

TEL: (925)938-0383

BID SUBMITTAL


DESIGNED BY:	R. OYEWOLE
DRAWN BY:	J. SORIA
CHECKED BY:	M. COOPER
PROJECT No.:	SJ-17123
DATE:	03/05/2020

LINDEN AVENUE PHASE 2 AND SPRUCE AVENUE TRAFFIC CALMING IMPROVEMENTS PROJECT - ATP LINDEN AVENUE WATER POLLUTION CONTROL PLAN

OLL	LUTI	0N	CONTROL	PΙ
0	10	20	40	
	SCA	_E: 1	"=20 <i>"</i>	

G	WPC-2	

44 —of— 56

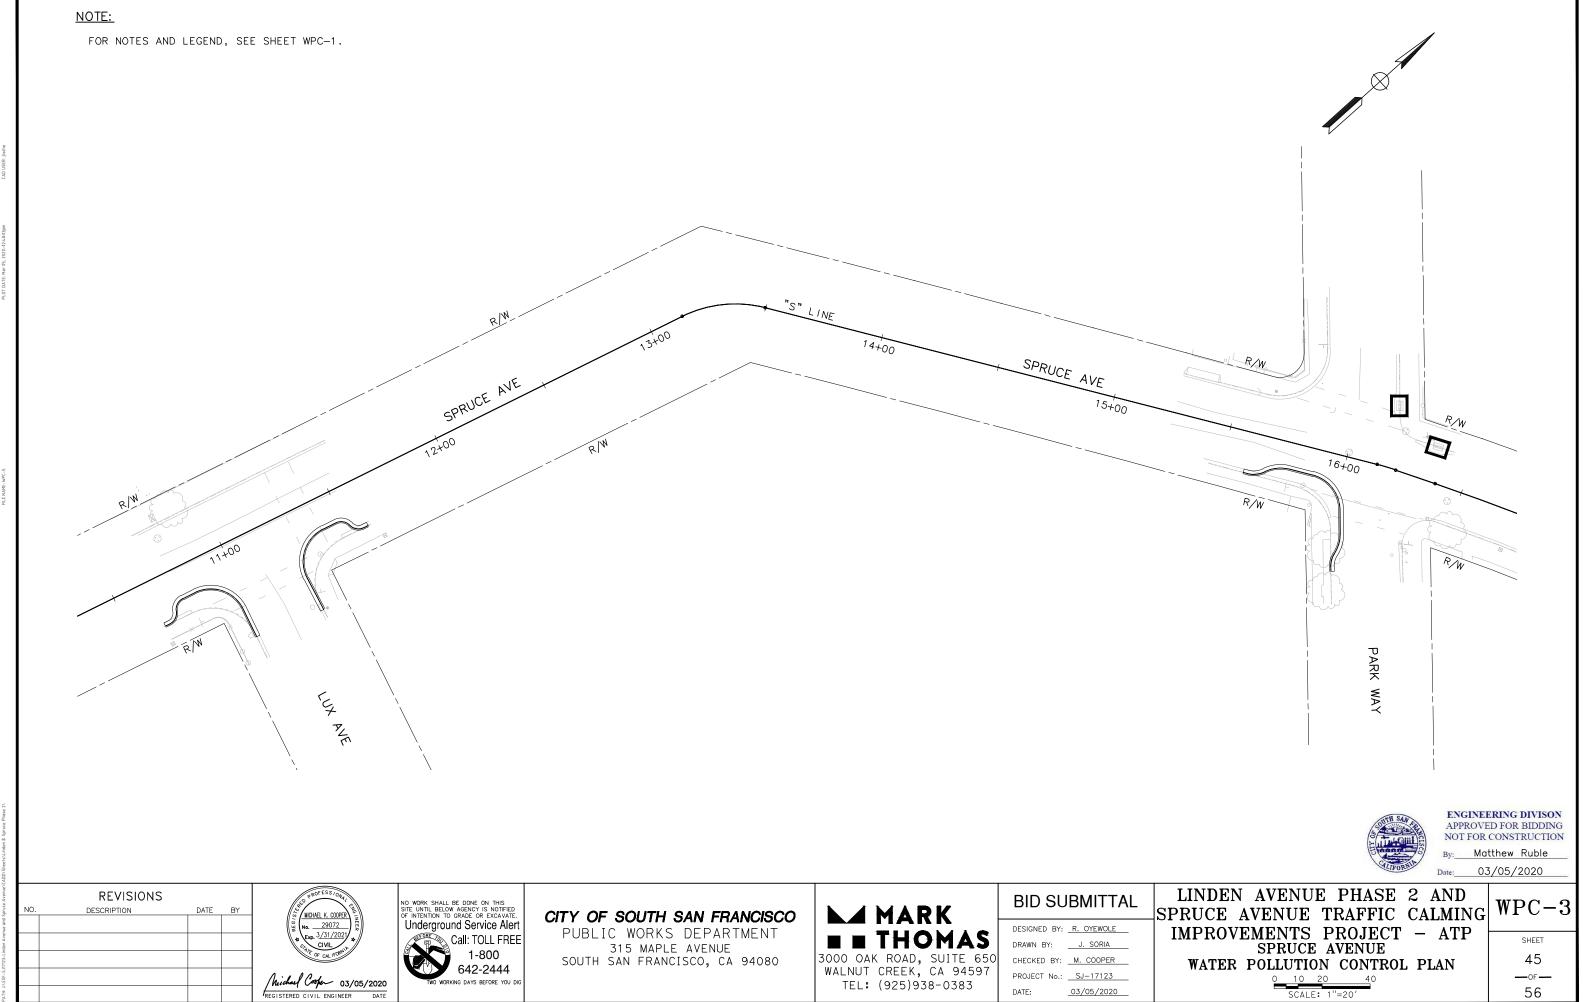

03/05/2020



ENGINEERING DIVISON APPROVED FOR BIDDING NOT FOR CONSTRUCTION By: Matthew Ruble Date: 03/05/2020

REVISIONS					
NO. DESCRIPTION DATE BY					



NO WORK SHALL BE DONE ON THIS SITE UNTIL BELOW AGENCY IS NOTIFIED OF INTENTION TO GRADE OR EXCAVATE.

Underground Service Alert Call: TOLL FREE 1-800 642-2444

CITY OF SOUTH SAN FRANCISCO PUBLIC WORKS DEPARTMENT

315 MAPLE AVENUE SOUTH SAN FRANCISCO, CA 94080

3000 OAK ROAD WALNUT CREEK

- TUOMAC	DESIGNED BY: R. OYEWOLE
■ ■ THOMAS	DRAWN BY: <u>J. SORIA</u>
00 OAK ROAD, SUITE 650	CHECKED BY: M. COOPER
ALNUT CREEK, CA 94597	PROJECT No.: SJ-17123
TEL: (925)938-0383	DATE: <u>03/05/2020</u>

BID SUBMITTAL


LINDEN AVENUE PHASE 2 AND SPRUCE AVENUE TRAFFIC CALMING IMPROVEMENTS PROJECT - ATP SPRUCE AVENUE WATER PO


$oldsymbol{old}$	L	J TI	0N	CONTROL	PL
)	10	20	40	
		SCAL	E: 1'	"=20"	

G	WPC-

46 ---OF---56

03/05/2020

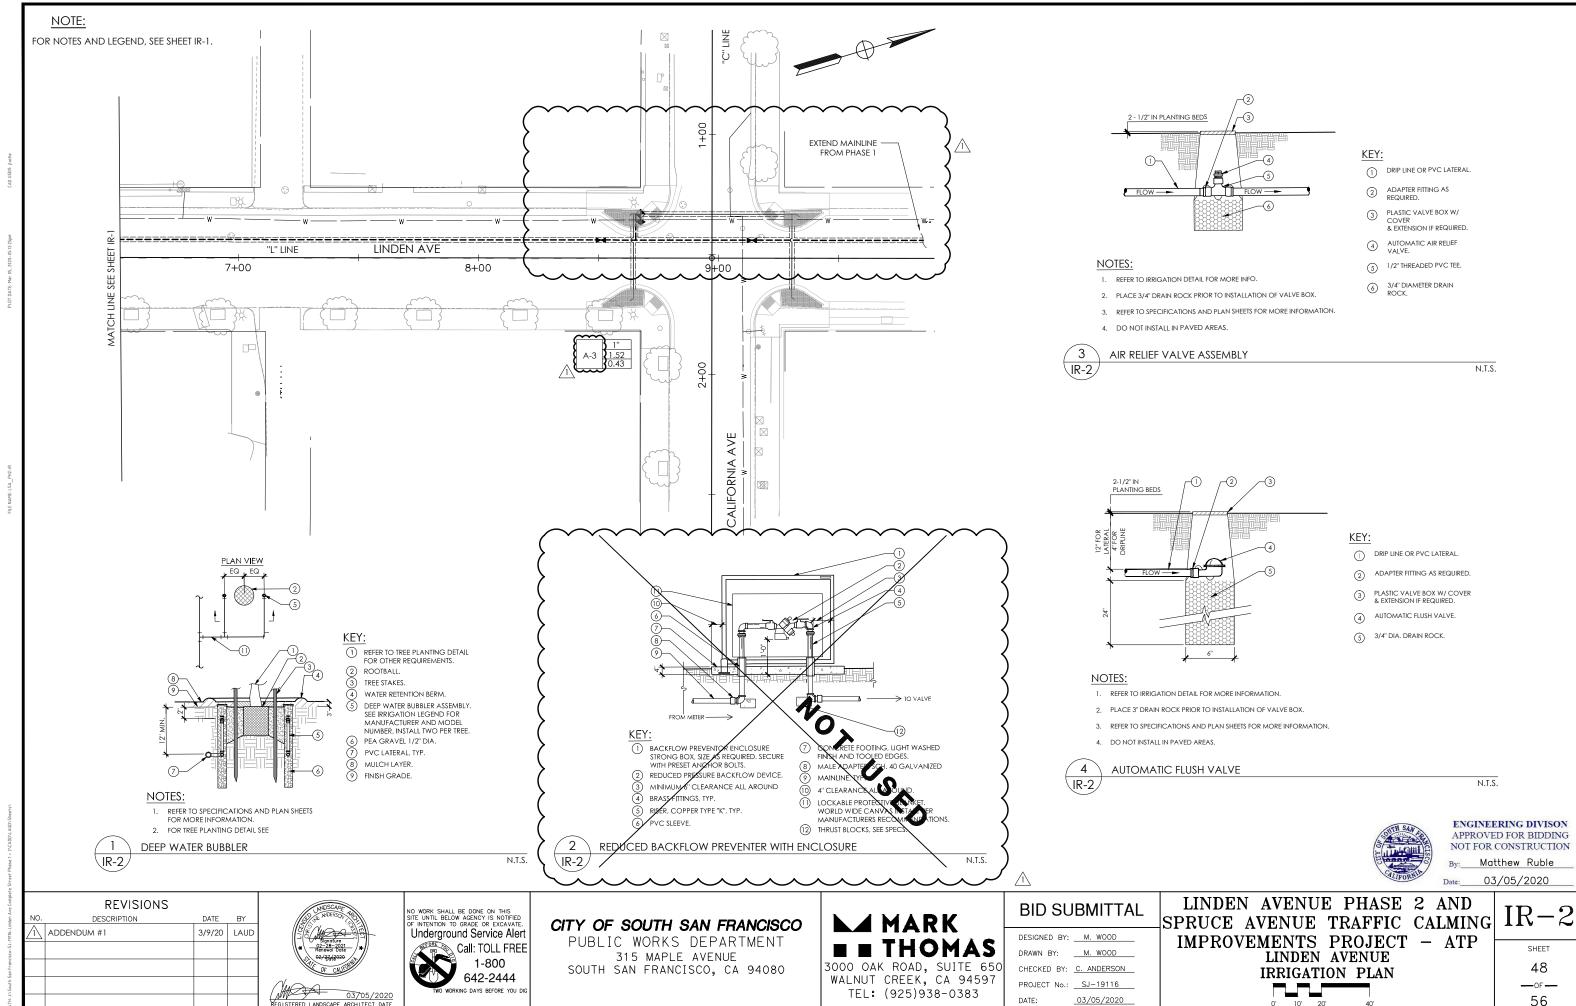

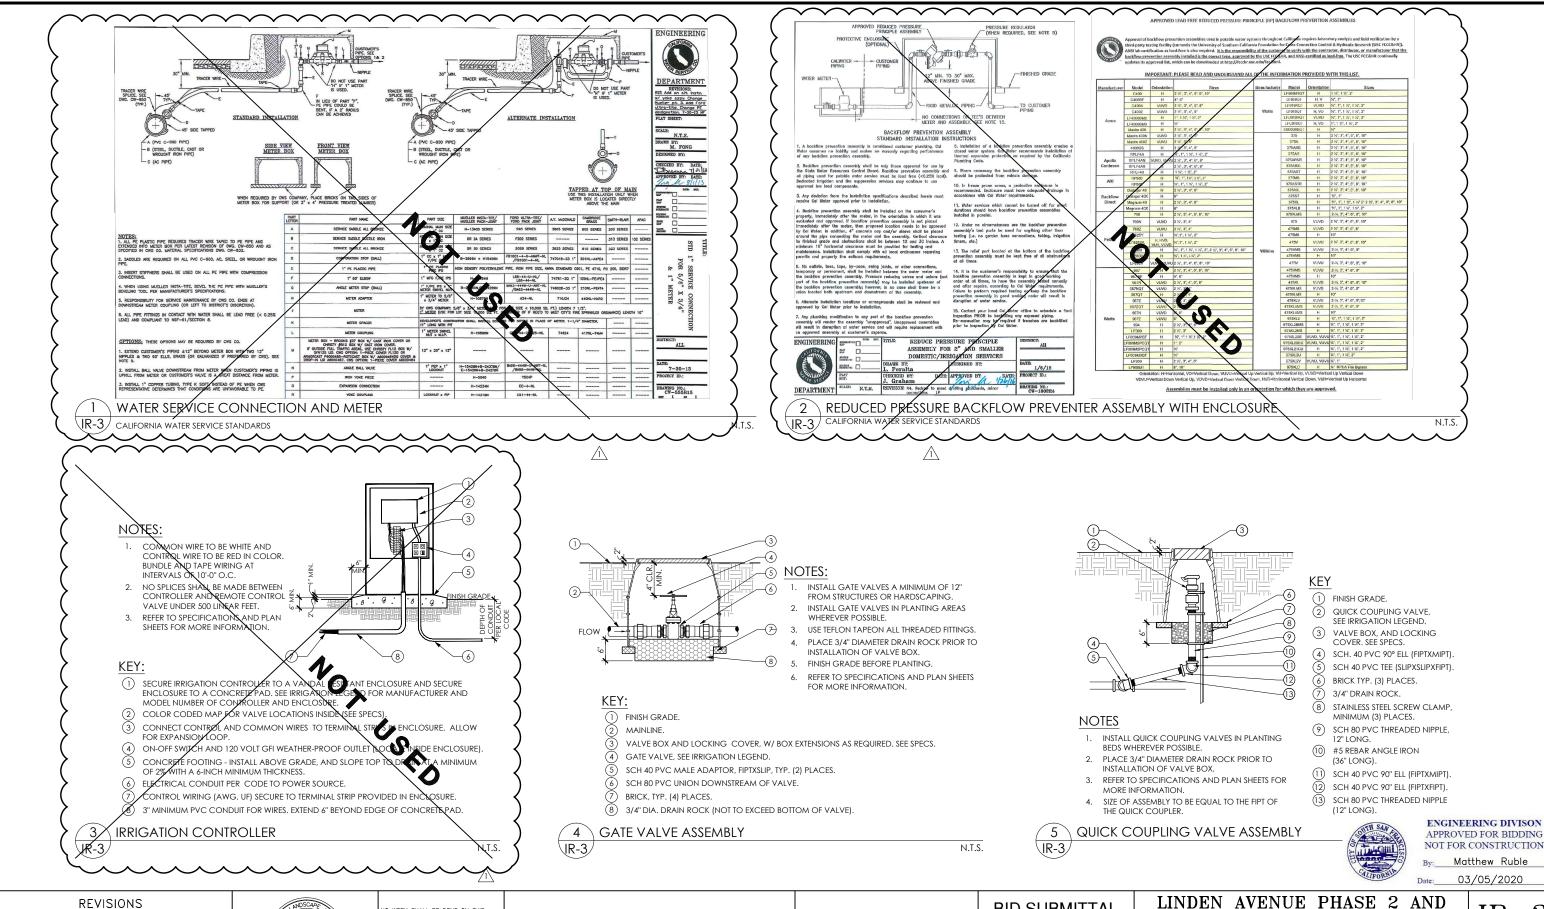

3/9/20 LAUD

DESCRIPTION

ADDENDUM #1



D WORK SHALL BE DONE ON THIS TE UNTIL BELOW AGENCY IS NOTIFIED F INTENTION TO GRADE OR EXCAVATE Underground Service Alert Call: TOLL FREE 1-800 642-2444

CITY OF SOUTH SAN FRANCISCO

PUBLIC WORKS DEPARTMENT 315 MAPLE AVENUE SOUTH SAN FRANCISCO, CA 94080

MARK

3000 OAK ROAD, SUITE 650 WALNUT CREEK, CA 94597 TEL: (925)938-0383


BID SUBMITTAL

DRAWN BY: M. WOOD CHECKED BY: C. ANDERSON PROJECT No.: SJ-19116 03/05/2020

LINDEN AVENUE PHASE 2 AND SPRUCE AVENUE TRAFFIC CALMING IMPROVEMENTS PROJECT - ATP SPRUCE AVENUE IRRIGATION PLAN

NO SCALE

49 ___OF ___

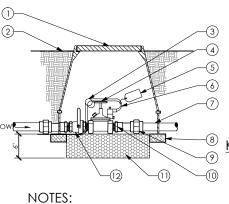

INSTALL VALVES A MINIMUM OF 12" FROM

PLACE 3/4" DIAMETER DRAIN ROCK PRIOR

STRUCTURES OR HARDSCAPING.

3. PLACE VALVE BOX AT RIGHT ANGLES TO

STRUCTURES OR HARDSCAPING.

TO INSTALLATION OF VALVE BOX. BALL VALVE AND FITTINGS SHALL BE LINE

SIZE UNLESS NOTED OTHERWISE.

SHEETS FOR MORE INFORMATION.

MASTER VALVE ASSEMBLY


REFER TO SPECIFICATIONS AND PLAN

2. INSTALL VALVES IN PLANTING BEDS

WHEREVER POSSIBLE.

- 1 VALVE BOX WITH BOLT DOWN COVER AND BOX EXTENSION IF REQUIRED. REFER TO SPECIFICATIONS.
- FLUSH IN PAVED AREAS, 2" IN PLANTING BEDS. PIG TAIL EXPANSION LOOP, MINIMUM 18".
- ELECTRIC CONTROL VALVE
- VALVE IDENTIFICATION TAG.
- CONTROL AND COMMON WIRES
- LATERAL LINE, ANGLE TO 12" MINIMUM DEPTH AS REQUIRED.
- INSTALL VALVE BOX SO THAT TOP OF VALVE BOX IS FLUSH WITH ADJACENT HARDSCAPE. STANDARD BRICK, TYP. TWO (2) PLACES.
 - SCH 80 PVC UNION DOWNSTREAM OF VALVE
 - 10 SCH 40 PVC MALE ADAPTER, TYP. TWO (2)
 - 3/4" DIAMETER DRAIN ROCK BELOW VALVE.
 - (12) BALL VALVE. SEE IRRIGATION LEGEND FOR MANUFACTURER AN MODEL NUMBER.

N.T.S.

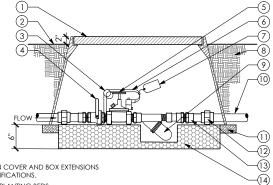


KEY:

- VALVE BOX WITH BOLT DOWN COVER AND BOX EXTENSIONS AS REQUIRED. REFER TO SPECIFICATIONS.
- FLUSH IN PAVED AREAS, 2" IN PLANTING BEDS.
- PIG TAIL EXPANSION LOOP, 18" MINIMUM.
- BALL VALVE. SEE IRRIGATION LEGEND FOR MANUFACTURER AND MODEL NUMBER.
- ELECTRIC CONTROL VALVE
- CONTROL AND COMMON WIRES.
- VALVE IDENTIFICATION TAG, REFER TO SPECIFICATIONS.
- FINISHED GRADE
- DRIP FILTER.
- LATERAL LINE, ANGLE TO 12" MINIMUM DEPTH AS REQUIRED.
- SCH 80 PVC UNION DOWNSTREAM OF VALVE.
- SCH 40 PVC ADAPTER, TYP.
- 3/4" DIAMETER DRAIN ROCK BELOW VALVE.

NOTES:

- 1. INSTALL VALVES A MINIMUM OF 1' 0" FROM STRUCTURES OR HARDSCAPING.
- 2. INSTALL VALVES IN PLANTING BEDS WHEREVER POSSIBLE.
- 3. PLACE VALVE BOX AT RIGHT ANGLES TO STRUCTURES OR HARDSCAPING.
- 4. INSTALL VALVE BOX SO THAT TOP OF VALVE BOX IS FLUSH WITH ADJACENT HARDSCAPING.
- 5. PLACE DRAIN ROCK PRIOR TO INSTALLATION OF VALVE BOX.
 6. BALL VALVE & FITTINGS SHALL BE LINE SIZE UNLESS NOTED OTHERWISE.
- REFER TO SPECIFICATIONS AND PLAN SHEETS FOR MORE INFORMATION.

N.T.S.

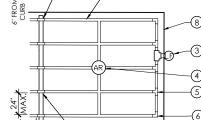

SUBSURFACE INLINE DRIP SYSTEM

KEY:

PVC TO DRIP LINE CONNECTION POINT (CENTER FEED SHOWN). SEE TECHLINE TO PVC CONNECTION POINT DETAIL, TYP.

ENGINEERING DIVISON APPROVED FOR BIDDING NOT FOR CONSTRUCTION Matthew Ruble 03/05/2020


N.T.S.

- DRIP LINE (BURIED 4") WITH EMITTERS.
- AUTOMATIC FLUSH VALVE, TYP.
- AIR RELIEF VALVE AT HIGHEST POINT BARBED TEE, TYP.
- BARBED ELL, TYP.
- PVC LATERAL.
- PERIMETE/EDGE OF PLANTING AREA.

NOTES:

- SPACING BETWEEN ROWS VARIES IN SLOPED CONDITIONS. REFER TO DRIP NOTES.
- LOCATE AN AIR-RELIEF VALVE AT THE HIGH POINT OF EACH SYSTEM WITHIN A PLASTIC BOX.
- 3. REFER TO SPECIFICATIONS AND PLAN SHEETS FOR MORE INFORMATION.



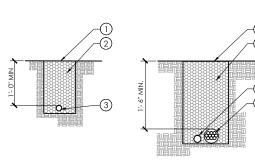

8. . . . 8 .

- 1) FINISH GRADE OF ASPHALT PAVING, CONCRETE OR OTHER IMPERVIOUS MATERIALS. SEE CIVIL PLANS.
- CLEAN BACKFILL 95% COMPACTION UNDER PAVING, SEE SPECS.
- (3) LATERAL LINE SLEEVE. UNDER PAVING (TWICE THE DIA. OF LATERAL LINE).
- (4) MAINLINE SLEEVE. UNDER PAVING (TWICE THE DIA. OF MAINLINE). (5) CONTROL WIRE CONDUIT UNDER PAVING. SIZE AS REQUIRED. INSTALL ADJACENT TO MAINLINE.

PIPE TRENCHING UNDER PAVEMENT

REFER TO SPECIFICATIONS AND PLAN SHEETS FOR MORE INFORMATION.

KEY:

- (1) FINISH GRADE.
- 2 CLEAN BACKFILL COMPACTED TO 85%.
- SEE SPECS.
- (3) LATERAL LINE.
- MAINLINE. CONTROL WIRE ADJACENT TO MAINLINE. SEE SPECS.

NOTES:

REFER TO SPECIFICATIONS AND PLAN SHEETS FOR MORE INFORMATION.

PIPE TRENCHING \IR-4

N.T.S.

TO IRRIGATION EXISTING PRESSURIZED WATER MAIN IRRIGATION POINT OF CONNECTION IRRIGATION SUPPLY LINE IRRIGATION WATER METER PROVIDED AND INSTALLED BY CALWATER IN ALVE BOX NOTES: FLOW SENSO FOR MORE INFORMATION ABOUT EQUIPMENT SEE GATE VALVE N VALVE BOX (R-3) IRRIGATION PLANS, LEGEND AND DETAILS. (10) EDGE OF PAVEMENT IRRIGATION POINT OF CONNECTION "B" LAYOUT N.T.S.

3/9/20 LAUD



WORK SHALL BE DONE ON THIS E UNTIL BELOW AGENCY IS NOTIFIED INTENTION TO GRADE OR EXCAVATE Underground Service Alert Call: TOLL FREE 1-800 642-2444

N.T.S.

CITY OF SOUTH SAN FRANCISCO

PUBLIC WORKS DEPARTMENT 315 MAPLE AVENUE SOUTH SAN FRANCISCO, CA 94080

⊿ MARK **■ THOMAS**

3000 OAK ROAD, SUITE 650 WALNUT CREEK, CA 94597 TEL: (925)938-0383

BID SUBMITTAL

DRAWN BY: M. WOOD CHECKED BY: C. ANDERSON PROJECT No.: SJ-19116 03/05/2020

LINDEN AVENUE PHASE 2 AND SPRUCE AVENUE TRAFFIC CALMING IMPROVEMENTS PROJECT - ATP LINDEN AVENUE IRRIGATION DETAILS

NO SCALE

SHEET 50

—OF — 56

- MULCH: INSTALL A UNIFORM TWO INCH COVERING, OF BARK MULCH, 1/4 INCH TO 3/4 INCH PARTICLE SIZE, IN ALL PLANTING AREAS.
- GROUNDCOVER: PROVIDE GROUNDCOVER AT INDICATED ON-CENTER SPACING THROUGHOUT ALL PLANTING AREAS. GROUNDCOVER SHALL BE PROVIDED UP TO THE WATERING BASIN OF ALL SHRUBS.
- BIOFILTRATION SOIL MEDIA: CONTRACTOR SHALL EXCAVATE ALL PLANTING AREAS TO A DEPTH PER CIVIL PLANS AND PLACE MEDIA PER SPECS AND CIVIL PLANS. SEE DETAILS.




Underground Service Alert

Call: TOLL FREE

1-800

642-2444

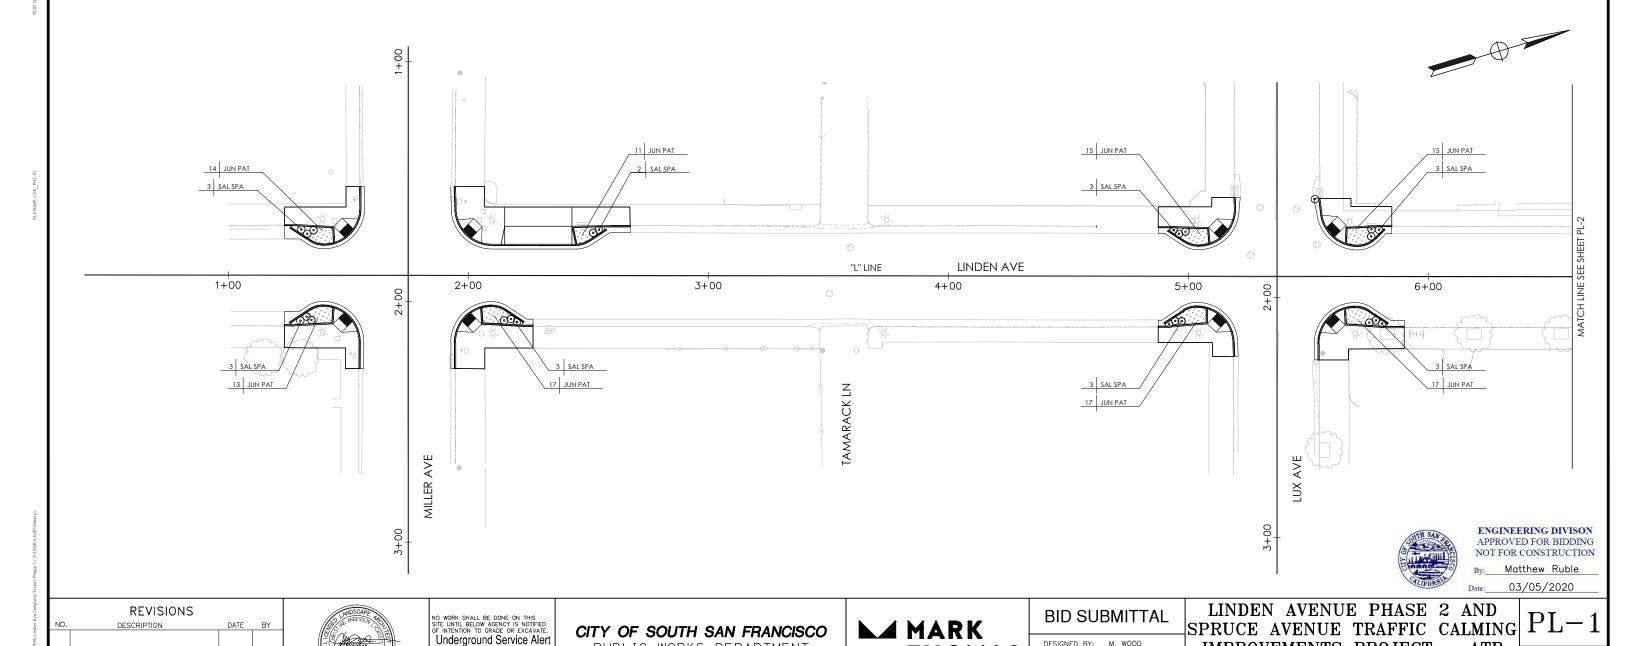

THOMAS

3000 OAK ROAD, SUITE 650

WALNUT CREEK, CA 94597

TEL: (925)938-0383

DRAWN BY: M. WOOD

CHECKED BY: C. ANDERSON

PROJECT No.: SJ-19116

03/05/2020

PUBLIC WORKS DEPARTMENT

315 MAPLE AVENUE

SOUTH SAN FRANCISCO, CA 94080

IMPROVEMENTS PROJECT - ATP

LINDEN AVENUE


PLANTING PLAN

SHEET

51

—OF **—**

FOR NOTES AND LEGEND, SEE SHEET PL-1.

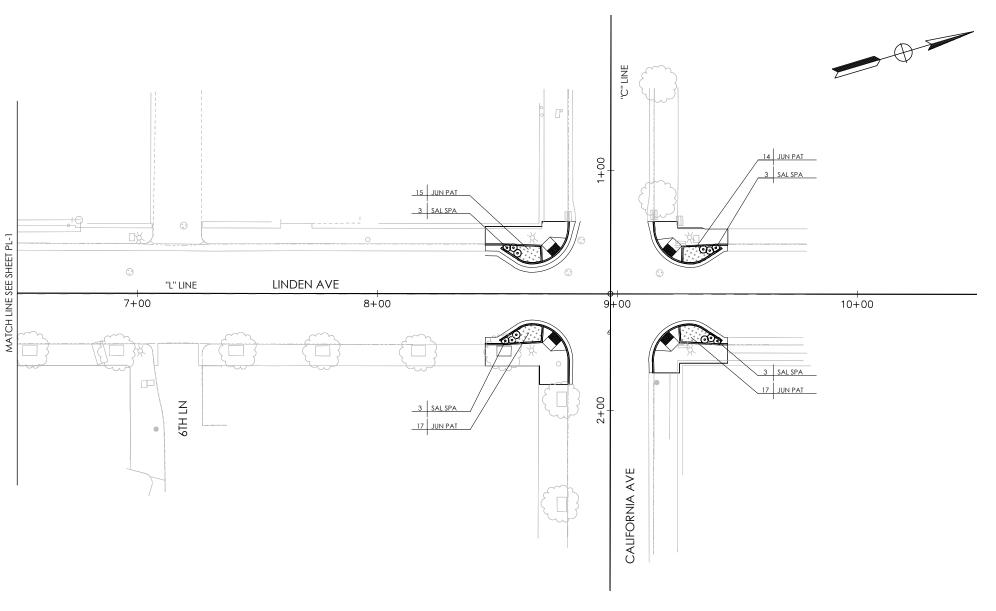

ENGINEERING DIVISON
APPROVED FOR BIDDING
NOT FOR CONSTRUCTION
By: Matthew Ruble
Date: 03/05/2020

REVISIONS					
NO. DESCRIPTION DATE BY					
l					
Н					



NO WORK SHALL BE DONE ON THIS SITE UNTIL BELOW AGENCY IS NOTIFIED OF INTENTION TO GRADE OR EXCAVATE.

Underground Service Alert

Call: TOLL FREE

1-800
642-2444

TWO WORKING DAYS BEFORE YOU DIG

CITY OF SOUTH SAN FRANCISCO

PUBLIC WORKS DEPARTMENT 315 MAPLE AVENUE SOUTH SAN FRANCISCO, CA 94080

MARK THOMAS 3000 OAK ROAD, SUITE 650 WALNUT CREEK, CA 94597

TEL: (925)938-0383


DESIGNED BY:	M. WOOD
DRAWN BY:	M. WOOD
CHECKED BY:	C. ANDERSON
PROJECT No.:	SJ-19116
DATE:	03/05/2020

BID SUBMITTAL

LINDEN AVENUE PHASE	2 AND
SPRUCE AVENUE TRAFFIC	CALMING
IMPROVEMENTS PROJECT	- ATP
LINDEN AVENUE	
PLANTING PLAN	

PL-2
SHEET

52 —of— 56

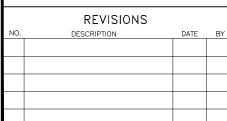





D WORK SHALL BE DONE ON THIS TE UNTIL BELOW AGENCY IS NOTIFIED F INTENTION TO GRADE OR EXCAVATE 1-800 642-2444

Call: TOLL FREE

N.T.S.

315 MAPLE AVENUE SOUTH SAN FRANCISCO, CA 94080

12" OPENING IN **BIOFILTER CURB**

6" OF CONC. EXTEND BEYOND

END OF CURB

BIOFILTRATION CURB INLET DETAIL

LIP OF GUTTER

FACE OF CURB

SIDEWALK

N.T.S.



M. WOOD CHECKED BY: C. ANDERSON PROJECT No.: SJ-19116 03/05/2020

LINDEN AVENUE PHASE 2 AND

SPRUCE AVENUE TRAFFIC CALMING PLANTING AND LAYOUT PLAN


IMPROVEMENTS PROJECT - ATP SPRUCE AVENUE

53

- BIOFILTRATION CURB AND GUTTER PER CIVIL PLANS.
 TOP OF ADJACENT CURB.
- 3 3" MULCH LAYER.
- CONCRETE SIDEWALK WITH THICKENED EDGE PER CIVIL DETAILS.
- BIOFILTRATION SOIL MEDIA.
- CLASS 2 PERMEABLE MATERIAL.
- (8) EXISTING SUBGRADE (UNCOMPACTED).
- 9 ROOT BARRIER (WHERE APPLICABLE).

BIOFILTRATION SECTION PL-3

N.T.S.

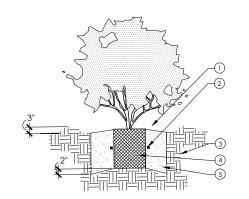


- BARK MULCH, SEE SPECIFICATIONS.
- FERTILIZER TABLETS, SEE SPECIFICATIONS.
- SURROUND SOIL MIX AND BACKFILL. SEE NOTES.
- ROOT BALL- SET CROWN 1" ABOVE FINISH GRADE. PROVIDE POSITIVE DRAINAGE AWAY FROM ROOTBALL.
- (5) PLANTING PIT TO BE TWICE THE DIAMETER OF ROOTBALL.

- REFER TO SPECIFICATIONS AND PLAN SHEETS
- 2. BACKFILL AND SOIL MIX PER DETAIL.

SHRUB PLANTING \PL-3/

N.T.S.

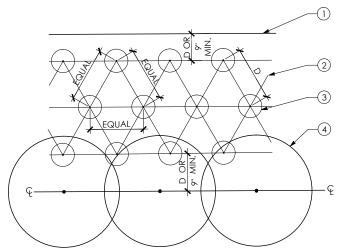

KEY:

RAMP PER CIVIL PLANS

3 PLANTER AREA

② SIDEWALK PER CIVIL PLANS

5 BIOFILTRATION CURB INLET

4 GUTTER FLOW LINE SEE CIVIL PLANS.

6 CONCRETE GUTTER PER CIVIL PLANS

N.T.S.

KEY:

PL-3

- (1) MOW CURB, PAVEMENT EDGE, OR WOOD HEADER.
- (2) TYPICAL SPACING (D). SEE PLANTING PLAN.

BIOFILTRATION PLANTER

- 3 GROUNDCOVER PLANT, SIZE AS DENOTED ON PLANTING PLAN.
- 4 SHRUB MASS, TYP.

SHRUB AND GROUNDCOVER SPACING

CITY OF SOUTH SAN FRANCISCO PUBLIC WORKS DEPARTMENT

BID SUBMITTAL

---OF---56


PL-3

BIOFILTER PLANTER

AREA

WALNUT CREEK, CA 94597 TEL: (925)938-0383



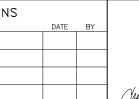

Underground Service Alert

NO SCALE

BASIS OF BEARINGS AND COORDINATES:

THE COORDINATES AND BEARINGS SHOWN HEREON ARE BASED UPON THE CALIFORNIA COORDINATE SYSTEM OF 1983, CCS83, ZONE 3, (2011.00) IN ACCORDANCE WITH THE CALIFORNIA PUBLIC RESOURCES CODE SECTIONS 8801-8819; SAID COORDINATES AND BEARINGS ARE BASED LOCALLY UPON FIELD-OBSERVED TIES TO THE FOLLOWING CALIFORNIA SPATIAL REFERENCE NETWORK (CSRN), OR EQUIVALENT STATIONS:

REFERENCED CSRN STATIONS(S) CONNECTED:					
POINT	NORTHING	EASTING	ELEVATION		
CAPO	2087091.29	6063572.64	40.06		
P176	1999593.79	6022762.06	1532.07		

BASIS OF ELEVATION:

ELEVATIONS ARE NAVD 88 AND BASED LOCALLY UPON THE SAME FIELD-OBSERVED TIES.


SURVEY CONTROL TABLE

NUMBER	NORTHING	EASTING	ELEVATION	DESCRIPTION
1010	2067402.01	6008937.36	37.83	SVBS 1010
1011	2067675.05	6009083.15	44.26	CUT X
1100	2067893.04	6009094.59	50.28	SVCX-SET
1200	2067534.97	6008992.16	40.46	SVNS-SET
1201	2067195.40	6008939.56	35.77	SVNS-FND
1202	2067041.88	6008893.58	34.51	SVMC SURVEY SP

LEGEND:

▲ SURVEY CONTROL POINT



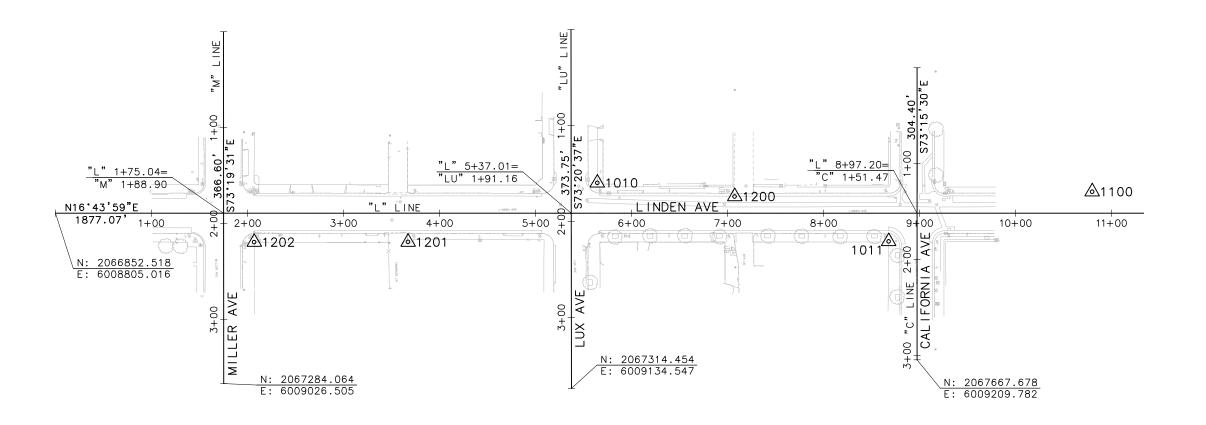



REVISIONS

DESCRIPTION



NO WORK SHALL BE DONE ON THIS SITE UNTIL BELOW AGENCY IS NOTIFIED OF INTENTION TO GRADE OR EXCAVATE. Underground Service Alert Call: TOLL FREE 1-800 642-2444

CITY OF SOUTH SAN FRANCISCO

PUBLIC WORKS DEPARTMENT 315 MAPLE AVENUE SOUTH SAN FRANCISCO, CA 94080

⊿ MARK **THOMAS** 3000 OAK ROAD, SUITE 650 WALNUT CREEK, CA 94597

TEL: (925)938-0383

DESIGNED BY:	R. OYEWOLE
DRAWN BY:	J. SORIA
CHECKED BY:	T. BOHAN
PROJECT No.:	SJ-17123
DATE:	03/05/2020

BID SUBMITTAL

LINDEN AVENUE PHASE 2 AND SPRUCE AVENUE TRAFFIC CALMIN IMPROVEMENTS PROJECT - ATP LINDEN AVENUE SURVEY CONTROL DIAGRAM

ENGINEERING DIVISON APPROVED FOR BIDDING NOT FOR CONSTRUCTION By: Matthew Ruble Date: 03/05/2020

SCALE: 1"=50'

G	SD-1	
	SHEET	
	54	

—OF — 56

BASIS OF BEARINGS AND COORDINATES:

THE COORDINATES AND BEARINGS SHOWN HEREON ARE BASED UPON THE CALIFORNIA COORDINATE SYSTEM OF 1983, CCS83, ZONE 3, (2011.00) IN ACCORDANCE WITH THE CALIFORNIA PUBLIC RESOURCES CODE SECTIONS 8801-8819; SAID COORDINATES AND BEARINGS ARE BASED LOCALLY UPON FIELD-OBSERVED TIES TO THE FOLLOWING CALIFORNIA SPATIAL REFERENCE NETWORK (CSRN), OR EQUIVALENT STATIONS:

REFERENCED CSRN STATIONS(S) CONNECTED:			
POINT	NORTHING	EASTING	ELEVATION
CAPO	2087091.29	6063572.64	40.06
P176	1999593.79	6022762.06	1532.07

BASIS OF ELEVATION:

ELEVATIONS ARE NAVD 88 AND BASED LOCALLY UPON THE SAME FIELD-OBSERVED TIES.


SURVEY CONTROL TABLE

NUMBER	NORTHING	EASTING	ELEVATION	DESCRIPTION
1203	2069331.23	6008600.71	110.51	SVCX-SET
1204	2069328.08	6008732.44	93.20	SVCX-SET
1205	2069514.17	6008940.79	72.48	SVCX-SET
1206	2068229.64	6007512.91	148.28	SVCX-SET
1207	2067977.13	6007265.67	135.31	SVCX-SET
1208	2068418.60	6008123.38	155.47	SVCX-SET
1209	2068764.73	6008352.80	154.63	SVCX-SET
1210	2068575.25	6008278.70	140.57	WORK PT
1211	2068362.85	6007966.50	150.85	WORK PT

LEGEND:

▲ SURVEY CONTROL POINT



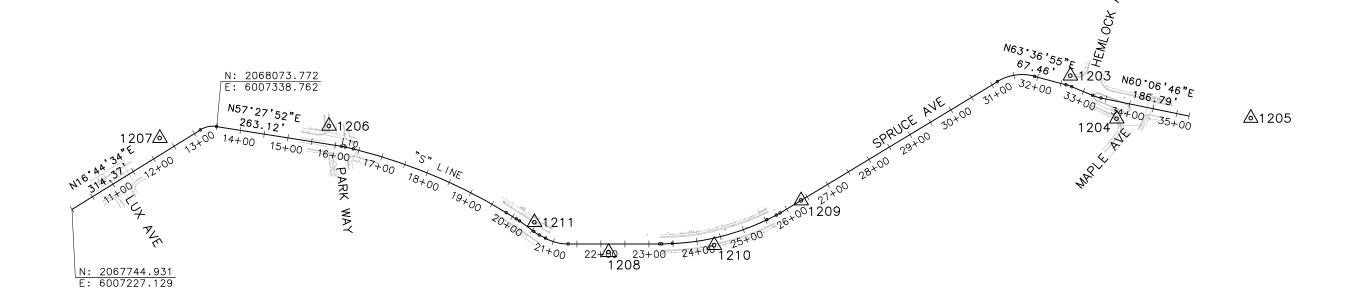



ENGINEERING DIVISON APPROVED FOR BIDDING NOT FOR CONSTRUCTION By: Matthew Ruble Date: 03/05/2020

l	REVISIONS		
NO.	DESCRIPTION	DATE	BY
\vdash			





CITY OF SOUTH SAN FRANCISCO

PUBLIC WORKS DEPARTMENT 315 MAPLE AVENUE SOUTH SAN FRANCISCO, CA 94080

	MA	RK	
	TH	OM	AS
3000 OA	AK ROAD	, SUITE	650
WALNUT	CREEK.	, CA 9	4597

TEL: (925)938-0383

E	3ID	SU	IBM	IIT	ΓAL

DESIGNED BY:	R. OYEWOLE	
DRAWN BY:	J. SORIA	
CHECKED BY:	T. BOHAN	
PROJECT No.:	SJ-17123	
DATE:	03/05/2020	

LINDEN AVENUE PHASE 2 AND SPRUCE AVENUE TRAFFIC CALMING SD-2 IMPROVEMENTS PROJECT - ATP SPRUCE AVENUE SURVEY CONTROL DIAGRAM

SCALE: 1"=100'

55

__OF __ 56

ALL ELECTRICAL WORK SHALL CONFORM TO THE LATEST VERSION OF THE CITY OF SOUTH SAN FRANCISCO STANDARDS, 2015 STATE (CALTRANS) REVISED STANDARD SPECIFICATIONS AND PLANS, AND THE 2014 CA MUTCD.

ABBREVIATIONS:

RECTANGULAR RAPID FLASHING BEACON SYSTEM

SYMBOLS:


1-1

RRFB

LEGEND (FOR THIS SHEET ONLY):


1 FURNISH AND INSTALL TYPE 1-B POLE, SOLAR ENGINE, ON-BOARD INTERFACE, RRFB LIGHTING BARS WITH SIDE AMBER LED INDICATIONS AND APS. SEE DETAIL A ON THIS SHEET.


2 USE CAUTION WHEN INSTALLING POLE FOUNDATION NEAR UTILITIES.

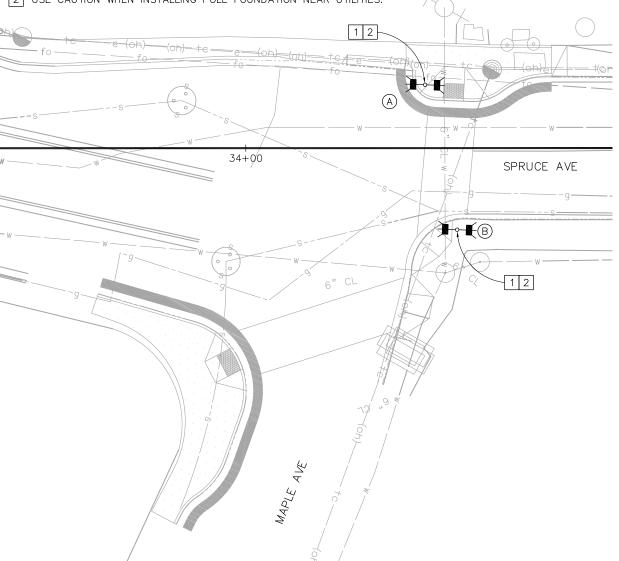

EQUIPMENT SCHEDULE STANDARD NO. REMARKS QUADRANT TYPE ARROW \bigcirc 1-B (16') SEE DETAIL A ON THIS SHEET EAST 1-B (16') SEE DETAIL A ON THIS SHEET

RRFB SHALL BE CARMANAH MODEL SC315 OR APPROVED EQUAL.

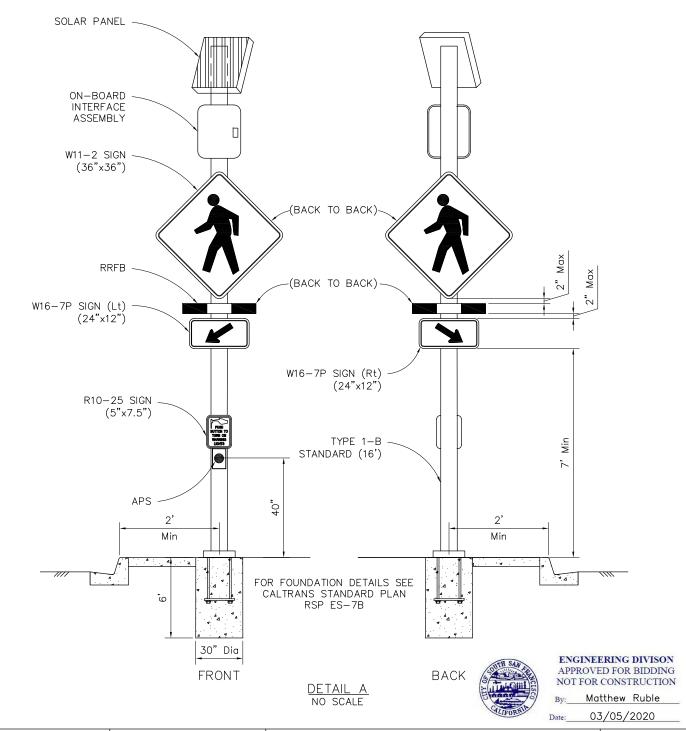

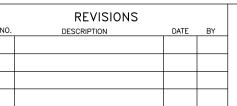



NO WORK SHALL BE DONE ON THIS SITE UNTIL BELOW AGENCY IS NOTIFIED OF INTENTION TO GRADE OR EXCAVATE Underground Service Alert Call: TOLL FREE 1-800 642-2444

CITY OF SOUTH SAN FRANCISCO PUBLIC WORKS DEPARTMENT 315 MAPLE AVENUE SOUTH SAN FRANCISCO, CA 94080

Ŷ	Y&C TRANSPORTATION CONSULTANTS, INC.
& C	3250 RAMOS CIRCLE SACRAMENTO, CA 95827 (916) 366-8000 FAX: (916) 366-8008

BID SUBMITTAL

DESIGNED BY: K. CHAN DRAWN BY: CHECKED BY: D. YAU PROJECT No.: SJ-17123 03/05/2020

TRAFFIC CALMING IMPROVEMENTS PROJECT PHASE 2

RECTANGULAR RAPID FLASHING BEACON SYSTEM

SCALE: 1"=10'

SHEET 56 ---OF---56